

Underground utility, structure and facility locations depicted and noted hereon have been compiled, in part, from record mapping supplied by the respective utility companies or governmental agencies, from parol testimony and from other sources. These locations <u>must</u> be considered approximate in nature. Additionally, other such features may exist on the site, the existence of which are unknown to C.C.G. The size, location and existence of all such features must be field determined and verified by the appropriate authorities prior to construction. Call Before You Dig 1-800-922-4455.

STORM MH TF=5.06

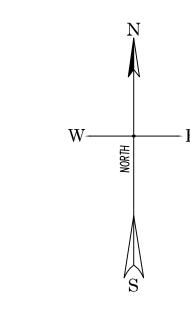

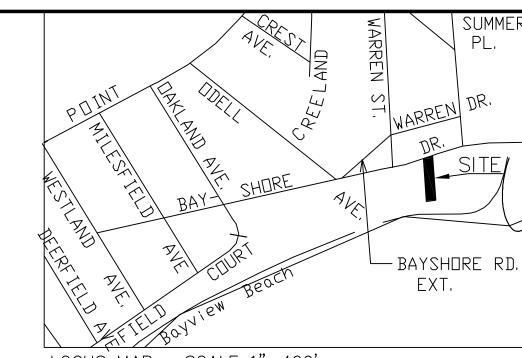

LOCUS MAP SCALE 1"=400' MAP 029 BLOCK 585 PARCEL 4

<u>LEGEND</u>

LIGHT POLE CATCH BASIN, TYPE "CL" CATCH BASIN, TYPE "C" STORM SEWER MANHOLE SANITARY SEWER MANHOLE DRY WELL

GAS VALVE WATER VALVE WATER SHUTOFF

EXISTING HYDRANT £ TREE SHRUB

MON IRON PIPE IRON PIN

— o — CHAIN LINK FENCE

DRILL HOLE OOOOO STONEWALL \_\_\_ STOCKADE FENCE

LOT NUMBERS PER MAP 3A

7X9 EXISTING SPOT GRADE PROPOSED SPOT GRADE

FLOOD VENT FV□

ELECTRIC METER AC COMPRESSOR

TRANSFORMER RDOROOF DRAIN

> P-D PROPOSED ROOF DRAIN PIPE P-UGE PROPOSED UNDERGROUND ELECTRICAL

P-GAS PROPOSED GAS LINE P-San PROPOSED SANITARY SEWER

P-W PROPOSED WATER

Zoning Requirements — Zone R-5 (One Family Residential) Existing Minimum Required Proposed Lot and Building Requirements Conditions Maximum Allowed Conditions Minimum Lot Requirements 5,000 SF 8,471± SF (EXIST) 8,471± SF (EXIST) Minimum Lot Area Minimum Lot Width 50.0 Feet 39.40 Feet (EXIST) 39.40 Feet (EXIST) Principal Uses Minimum Lot Depth 215.3± Feet(EXIST)|215.3± Feet(EXIST) 70 Feet Minimum Front Yard 39.79 Feet 33.5 Feet 10 Feet 4.34 Feet \*\*\* Minimum One Side Yard\*\* 3.96 Feet Minimum Other Side Yard\*\* 5 Feet 4.66 Feet 5.0 Feet Minimum Rear Yard 20 Feet 69.0± Feet 65.2± Feet Maximum Permitted 3 Building Height Stories 35 Feet 35.0 Feet Feet (in height) 45 *%* 32.0 % Building Area as % of Lot 65 **%** 51.2 % Lot Coverage

\*Ten Feet Or The Actual Front Yard Setback, Whichever Is Greater, except that the minimum required front yard shall not be required to exceed 20 feet. \*\*One side 10 feet, other side 5 feet

\*\*\*Variance approved August 10, 2021

# CONSTRUCTION NOTES:

- VERIFY ALL BUILDING DIMENSIONS WITH BUILDING PLAN PRIOR
- TO CONSTRUCTION CONSTRUCT SILT FENCE AROUND PERIMETER OF LOT INSTALL ANTI-TRACKING PAD
- CONNECT ROOF DRAINS TO PROPOSED GALLEYS

nor warranty, expressed or implied.

- PROPOSED BUILDINGS TO BE CONNECTED TO MUNICIPAL SANITARY SEWER AND WATER OR APPROVED SPETIC SYSTEM OR APPROVED WELL.
- RECONSTRUCT CONC. APRON AND CURBING AS REQUIRED BY MILFORD PUBLIC WORKS.
- ALL WORK WITHIN MUNICIPAL STREET TO BE CONDUCTED PER
- MILFORD PUBLIC WORKS STANDARDS. ALL WORK WITHIN CDOT RIGHT OF WAY REQUIRE AN ENCROACHMENT PERMIT FROM CDOT.
- ALL PROPOSED CATCH BASINS TO BE PROVIDED WITH 4' SUMPS AND HOODED OUTLETS

## NOTES:

- 1. The Total Area of the Parcel is 8,471  $\pm$  sq. ft.; 0.194 Acres.
- 2. The Parcel is in Zone R5.

# 3. Map References:

- A. Map on File in Milford Land Records, "MAP OF LOTS FOR SALE BY GEORGE E. HASKINS, BAY-VIEW, MILFORD, CT," dated June 30, 1918. MLR #E-330
- B. Map entitled, "Property Survey, 28 Bayshore Drive, Lot #65, Map of Lots for Sale by George E. Haskins, Bay-View, Milford, Connecticut," dated August 26, 1998.

#### 4. Deed Reference: Volume 2221 Page 662+663

- 5. The Parcel is in Flood Zone VE—13 as scaled from FIRM, City of Milford, New Haven County, Panel 534 of 635, Community Panel Number 09009C0534J, Map revised 7/8/2013.
- 6. North Rotation is based on NAD83.
- 7. Vertical Datum is based on NAVD 1988.
- 8. Property lies within the Coastal Management Area



This survey and map has been prepared pursuant to the Regulations of Connecticut State Agencies Sections 20-300b-1 through 20-300b-20 and the "Standards for Survey and Maps in the State of Connecticut" as adopted by the Connecticut Association of Land Surveyors, Inc. on September 26, 1996.

RECONSTRUCT "CL" CB TO BE ON EXISTING GUTTERLINE TF=4.2 (MATCH EXISTING GRADE)

Sta.17+84.7

EDGE OF PAVEMENT ATT

PROPERTY CORNER

N 636583.15 E 922775.77

EXISTING LATERAL

-2.84' ROOF TO PROPERTY LINE Variance approved August 10, 2021

PROPERTY LINE Variance approved August 10, 2021

#24 BAYSHORE DR

029/585/5

DILIETO FRANK III

Variance approved

August 10, 2021

VGARAGE FLOOR

ELEV. = 6.8

ELEV. = 16.0 FVI LOWEST HORIZONTAL

MEMBER = 15.0

**ELEV 2.9'** 

-0X12

-0X01

PROPOSED 40LF OF 12"HD CONCRETE GALLEYS WITH 12" OF 1" BROKEN STONE ON THE SIDES

6"PVC OVERFLOW OUTLET CONNECTS TO

ROOF DRAINS CONNECTS TO GALLEYS

AND BOTTOM (TYPICAL)

RECONSTRUCTED CB

PROPOSED FLOOD VENT (TYPICAL)

PROPOSED ROOF DRAIN

ROOF DRAINS CONNECT

TO GALLEYS

PROPOSED CONC. APRON

5.0' HOUSE TO-

PROPERTY LINE

PROPOSED BALCONY PROJECTS 0.5' INTO

SETBACK WHERE 1.0'

PROPOSED BUILDING ROOF LINE PROJECTS

1.5' INTO SETBACK

Variance approved
August 10, 2021

WHERE 1.0' IS ALLOWED

#30 BAYSHORE DR

ZWEIMAN ARI &

TIMMER ASHLEY JT TENANTS

029/585/3

3.50' ROOF TO-PROPERTY LINE

Variance approved August 10, 2021

5.0' DECK TO-

64

PROPERTY LINE

IS ALLOWED

PROPOSED GAS LATERAL

BAYSHORE DRIVE APPROX. 18" A

PROPOSED
ANTI-TRACK PAD

PROPOSED ELECTRIC
METER - ACCESS FROM

MAIN STAIRS

12"WATER MAIN W

It is an Improvement Location Survey based upon a Dependent Resurvey and is intended to depict the position, horizontally and, where required, vertically, between particular existing or proposed improvements with respect to applicable municipal or statutory requirements. The purpose is to enable determination of compliance with said improvements.


This survey conforms to Horizontal Accuracy Class A-2.

To my knowledge and belief, this map is substant<mark>i</mark>ally correct as noted hereon This survey is not valid unless it bears a live signature and live sea No. 16975 No. 16975 The word "certify" is understood to be an expression of professional opinion by the land surveyor that is based on his best knowledge, information, and belief. As such, it constitutes neither a guarantee

SITE PLAN PREPARED FOR John Lombard 28 BAYSHORE DRIVE, MILFORD, CT ATE: October 19, 2021 FB: 469

DRAWN BY: LML CHECKED: RWW PROJECT No.: 2020-013

DWG No.: H304 SHT 1 of 2

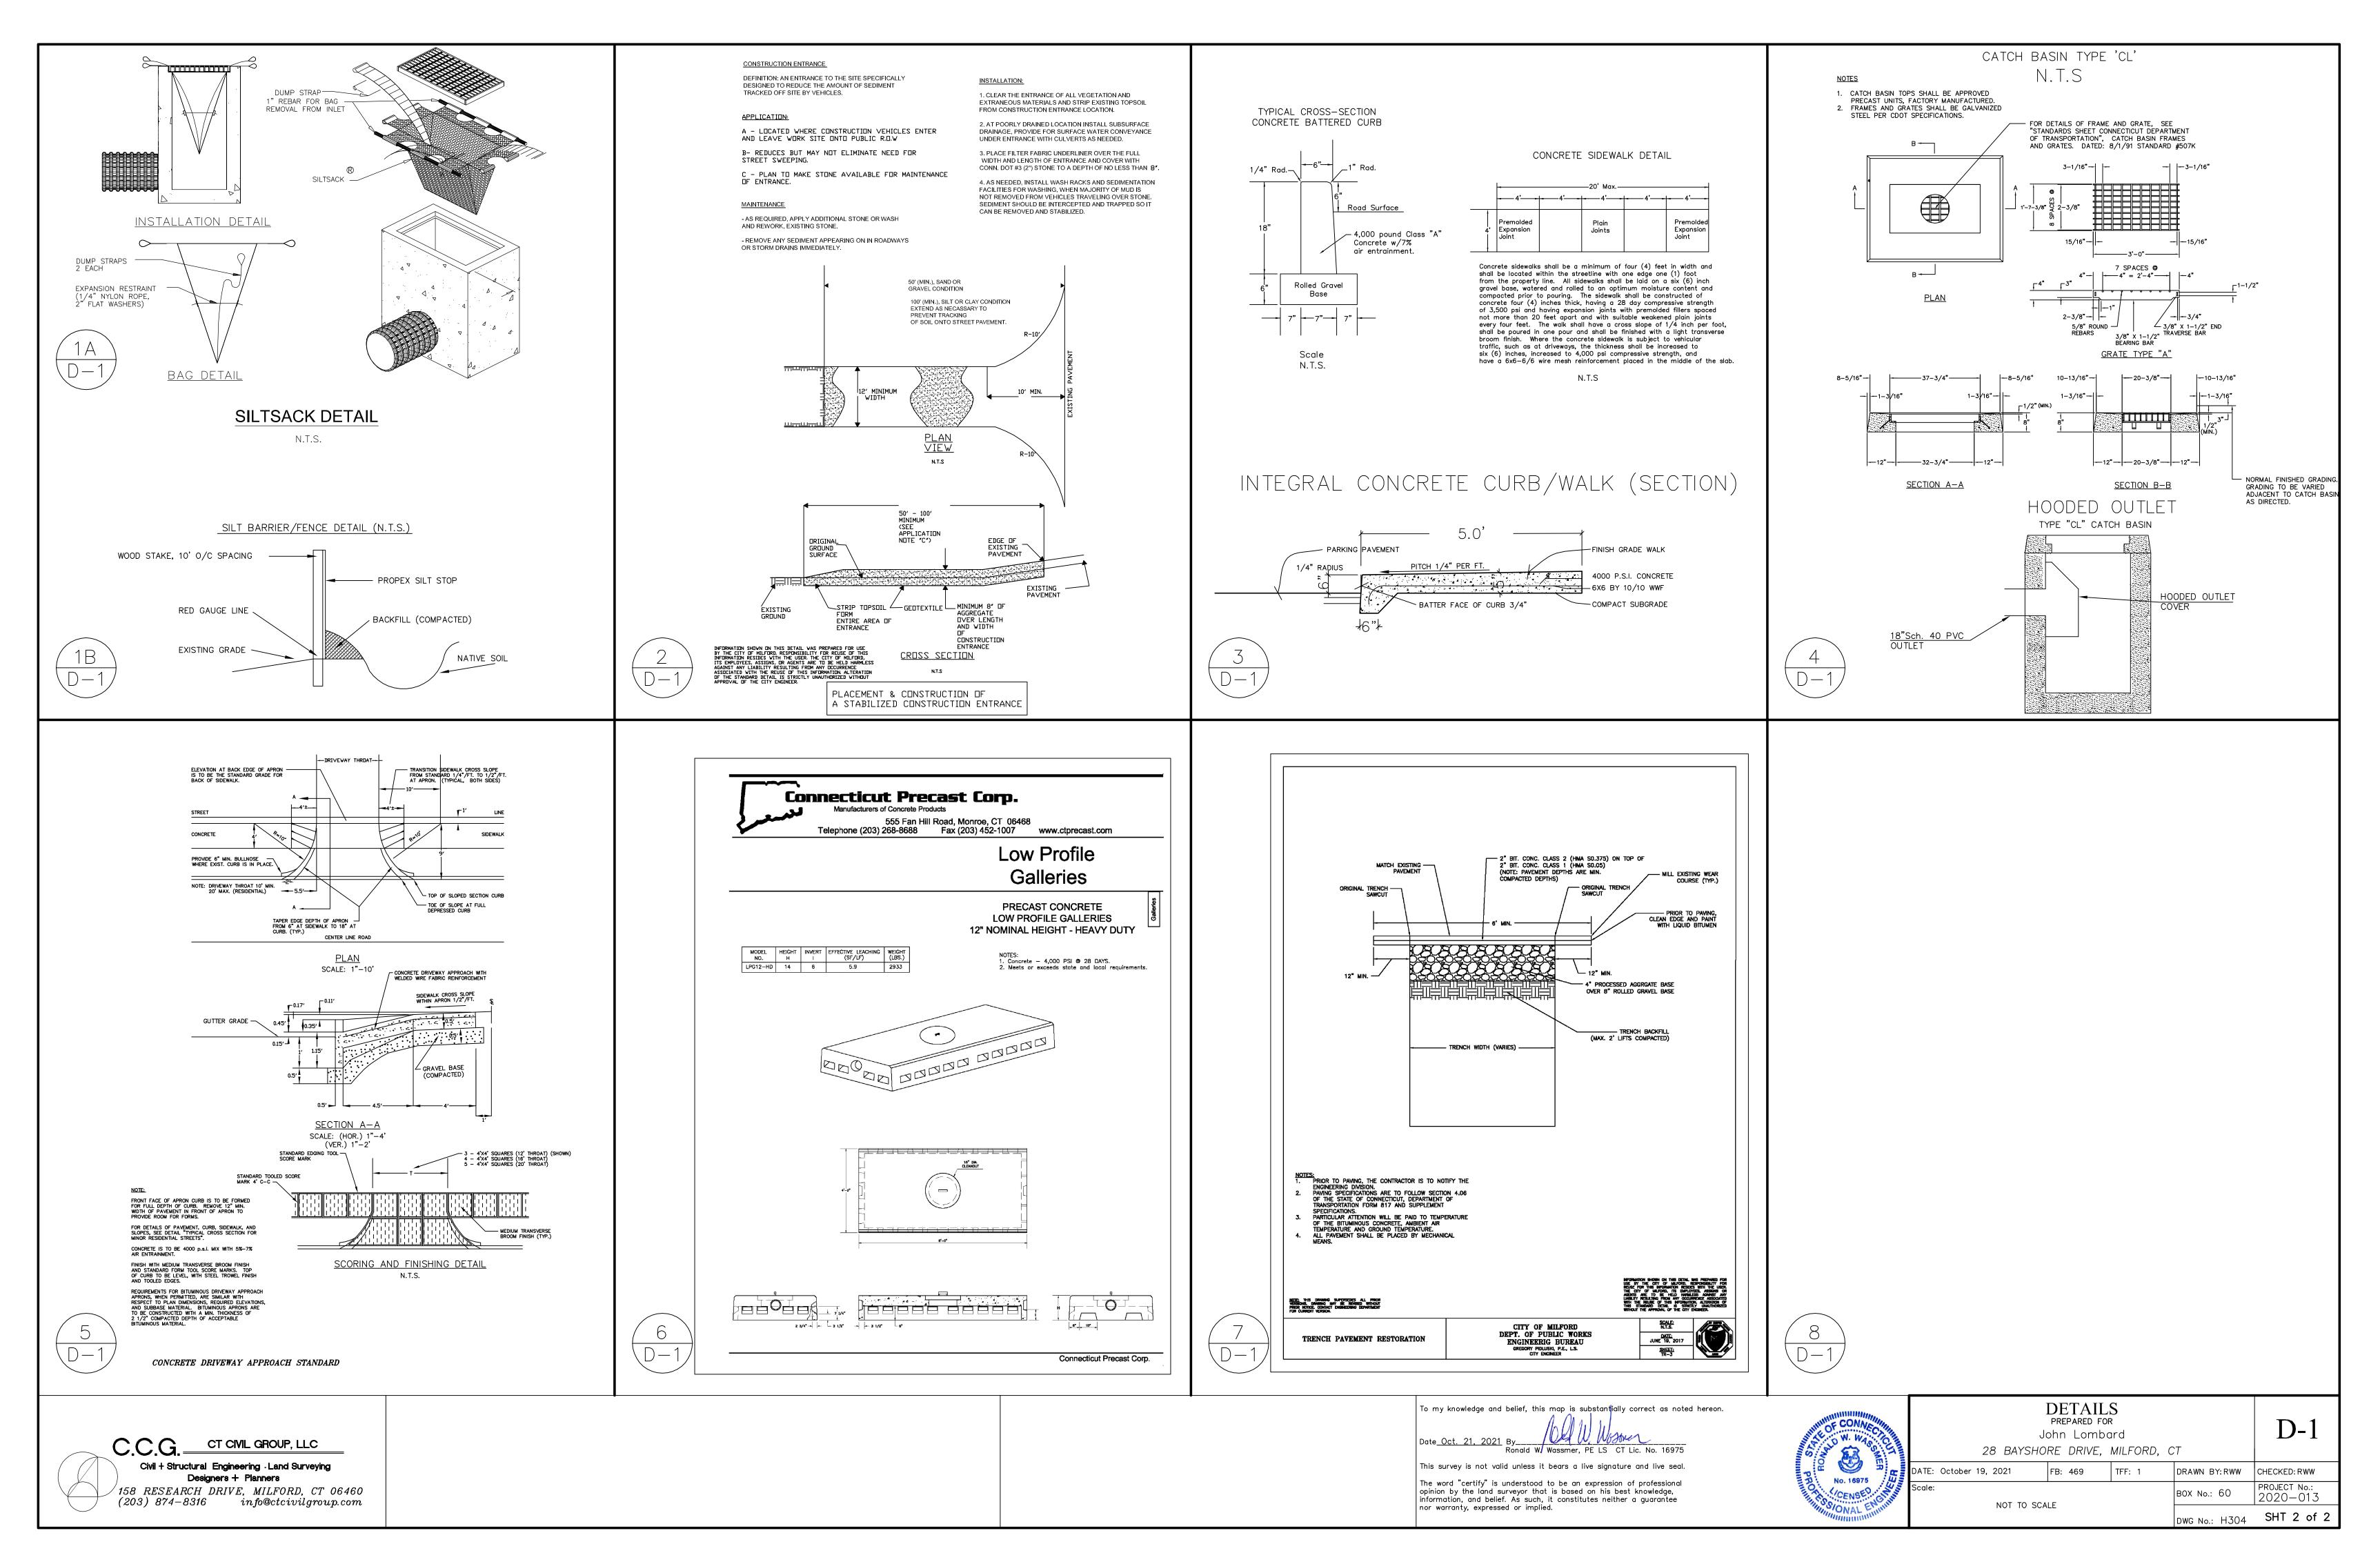

# THE LOMBARD RESIDENCE

28 Bayshore Drive - Milford, Connecticut



PATCH AND REPAIR ANY AND ALL EXTERIOR SIDING AS NEIEDED, OR REQUIRED.
 FINISHES THROUGHOUT ARE TO BE SELECTED BY OWNER.
 ALL WINDOWS WITHIN 18" OF THE FLOOR AND WITHIN 24" OF ANY DOOR ARE TO HAVE TEMPERED GLAZING.
 ALL WORK IS TO COMPLY WITH THE LATEST ADOPTED VERSION OF THE MASSACHUSETTS BUILDING CODE AND LOCAL REGULATIONS.
 THE CONTRACTOR IS RESPONSIBLE TO CHECK THE PLANS AND TO NOTIFY THE DESIGNER OF ANY ERRORS OR OMISSIONS PRIOR TO THE START OF CONSTRUCTION.
 WRITTEN DIMENSIONS HAVE PRECEDENCE OVER SCALED

DIMENSIONS.....DO NOT SCALE THE DRAWINGS.
7. DESIGN LOADS:

ROOF 35 PSF (LIVE LOAD) FLOOR 40 PSF STAIRS 100 PSF

(IF YOUR LOCAL AREA REQUIRES DIFFERENT DESIGN LOAD)'S CONSULT WITH A LOCAL STRUCTURAL ENGINEER TO DETERMINE THE APPROPRIATE REVISIONS.)

B. INSULATION

**GENERAL NOTES:** 

ROOF R-38 WALLS/EXTERIOR R-20 FLOOR (UNHEATED SPACE) R-30

9. THE ABOVE VALUES ARE THE MINIMUM AND MAY BE INCREASED IF DESIRED. VERIFY WITH OWNER.10. ALL EXPOSED INSULATION IS TO HAVE A FLAME SPREAD RATING

OF LESS THAN 25 AND A SMOKE DENSITY RATING OF LESS THAN 450.

11. PROVIDE INSULATION BAFFLES AT EAVE VENTS BETWEEN RAFTERS.

12. THE CONTRACTOR SHALL CARRY SUFFICIENT INSURANCE TO THE SATISFACTION OF THE OWNER.13. ALL PAINT, STAIN AND SHINGLE COLORS SHALL BE SELECTED BY THE OWNER.

14. ALL WINDOWS AND DOORS TO BE APPROVED BY THE OWNER,
CONTRACTOR TO CONFIRM WITH OWNER BEFORE FRAMING
OPENINGS FOR SIZE AND LOCATIONS.
15. ALL FLOOR COVER WILL BE CHOSEN BY THE OWNER, GENERAL

CONTRACTOR TO SUPPLY PROPER SUBFLOOR AS REQUIRED.

16. PRIOR TO STARTING CONSTRUCTION THE GENERAL
CONTRACTOR SHALL BE RESPONSIBLE TO VERIFY THAT ALL
REQUIRED PERMITS APPROVALS HAVE BEEN OBTAINED. NO
CONSTRUCTION OR ANY FABRICATION OF ANY ITEM SHALL BEGIN
UNTIL CONTRACTOR HAS RECEIVED ALL PLAN APPROVALS AND AN

OTHER DOCUMENTATION FROM ALL REGULATORY AUTHORITIES.
FAILURE OF THE CONTRACTOR TO FOLLOW THIS PROCEDURE SHAL
CAUSE THE CONTRACTOR TO ASSUME FULL RESPONSIBILITY FOR
ANY SUBSEQUENT MODIFICATION MANDATED BY ANY REGULATORY
AUTHORITY.

17. GENERAL CONTRACTOR SHALL WARRANTY ALL WORK FOR A

PERIOD OF ONE YEAR FROM THE DATE OF SUBSTANTIAL COMPLETION.


18. GENERAL CONTRACTOR IS RESPONSIBLE FOR DISPOSAL OF ALL PACKING AND OTHER RELATED TRASH INSIDE THE HOUSE AND AROUND THE SITE.



93 Sunnyside Ct. Milford, Connecticut 06460 (203) 882-8755

## **DRAWING INDEX**


ACT	Actual	DET.	Detail	IN	Inch	ОС	On Center	T.O.W.	Top of Wall
A.C.T.	Acoustic Tile	DIA.	Diameter	INCL	Include	OD	Outside Diameter	THK	Thick
ADH	Adhesive	DIAG.	Diagonal	INSUL	Insulation	OVHD	Overhead	TR	Tread
A.F.F.	Above Finish Floor	DK	Deck	INT	Interior	OPNG	Opening	T&G	Tongue & Groove
AGGR	Aggregate	DBL	Double	ID	Inside Diameter	OPP	Opposite	THRU	Through
AL/ALUM.	Aluminum	DN	Down			O.A.	Over-all	TYP.	Typical
ALLOW.	Allowance	DS	Downspout	JCT	Junction				. ypiodi
ALT	Alternate	DWG	Drawing	JT/JNT	Joint	PART.	Partition	ULT	Ultimate
APPD	Approved		g	JSTS	Joists	P.M.	Pressed Metal	<b>J</b>	Jillillate .
ASPH.	Asphalt	EA.	Each	33.3		P.C.	Precast (conc)	VCT	Vinyl Composite Ti
	Aophar	ELEC	Electric	KDN	Knock Down	P.T.	Pressure Treated	VENT.	Ventilate
3 <b>G</b>	Below Grade	EL.	Elevation	KIT	Kitchen	PERF	Perforate	VERT.	Vertical
BM	Beam	ELEV	Elevator	1211	Attonen	PLT	Plate	VOL.	Volume
BD.FT.	Board Feet	ENC/ENCL	Enclosure	LAM	Laminate	* *** 1	, late	VOL.	Volume
BRKT	Bracket	EQ	Equal	LAV	Lavoratory	QTR.	Quarter	WC	Watercloset
BRK./BR.	Building	EQUIP	Equipment	LBL	Label	QTR. BO.	Quarter Board	WD	Wood
3.0.	Block	EST	Estimate	L&P	Lath & Plaster	WIR. DU.	Quarter Board	WWF	Welded Wire Fabric
3.0. 3RS	Brick	EXT	Exterior	LDG	Latii & Flaster Landing	ъ	Radius	WH	Water Heater
BRZ	Bronze	EXP	Expansion	LB/LBS	Pounds	R RCP		WT	
JNZ.	Divilze	EXP	Expansion	LGMF	Light Gauge Metal Framing	RD.	Reinforced Concrete Pipe		Weight
CAB	Cabinet	FAB	Fabricate	LIN.	Light Gauge Metal Framing Linear	REF.	Round	W.T.	Watertight
CB	Catch Basin	FIN.	Finish	LOC	Location		Reference	WI	Wrought Iron
CEIL	Ceiling	FDTN	Foundation	LTG	Lighting	REQD REINF	Required	YD	Yard
CLKG	Caulking Caulking	FPRF	Fireproof	LVD	Lowered		Reinforced	YP	Yard Yield Point
C.L.	Centerline	F.O.S.	Face of Stud	LP		RM	Room	TP	Tiela Point
SEM	Cement	F.E.		LP	Low Point	R.O.	Rough Opening		
CLR	Clear	FLR	Fire Extinguisher Floor	nan:	Main	CUT	Shoot		
SEMM.	Cement Mortar	FLUOR	Fluorescent	MN Mas		SHT.	Sheet		
CER	Ceramic	FLASH		MATL	Masonry Material	SCH	Schedule Section		
).l.			Flashing			SECT	Section		
 C.M.U	Cast Iron	FT. FTNG.	Feet	MAX	Maximum	SQ.	Square		
	Concrete Masonry Unit		Footing	MIN	Minimun	SK	Sketch		
COL	Column	FV	Field Verify	MECH	Mechanical	SPEC	Specification		
CONC	Concrete			MED	Medium	STD	Standard		
C.J.	Control Joint	GA	Gauge	MEZZ	Mezzanine	SS	Stainless Steel		
COP.	Coping	GALV	Galvonized	MFG	Manufactured	STL	Steel		
CORB	Corpelled	GL	Glass Glazing	MH	Manhole	STRUC.	Structural		
CORR	Corrogated	GR	Grade	MEMB	Membrane	ST	Street/Stone		
CS S-	Cast Stone	G.W.B.	Gypsum Wall Board	M.O.	Masonry Opening	SUPV	Supervise		
CT C	Ceramic Tile			MISC	Miscellaneous	SUPT	Superintendent		
TO C	Center to Center	HDW	Hardware	MOD	Modification	S.T.C.	Sound Transmission Coefficient		
CTR	Center	HD	Head	MTL	Metal	SYS	System		
CU	Cubic	НМ	Hollow Metal						
CSK	Countersink	HOR	Horizontal	NAT	Natural	TAN	Tangent		
CRS	Courses	HGT	Height	NEC	National Electric Code	TEL	Telephone		
		HR	Hour	N.I.C	Not in Contract	TC	Terra Cotta		
		HP	Highpoint	NOM	Nominal	TER	Terrazzo		
		HWY	Highway	NO.	Number	ТОРО	Topography		
		HYD	Hydraulic	NTS	Not to Scale	T.O.C.	Top of Concrete		
						T.O.S.	Top of Steel		

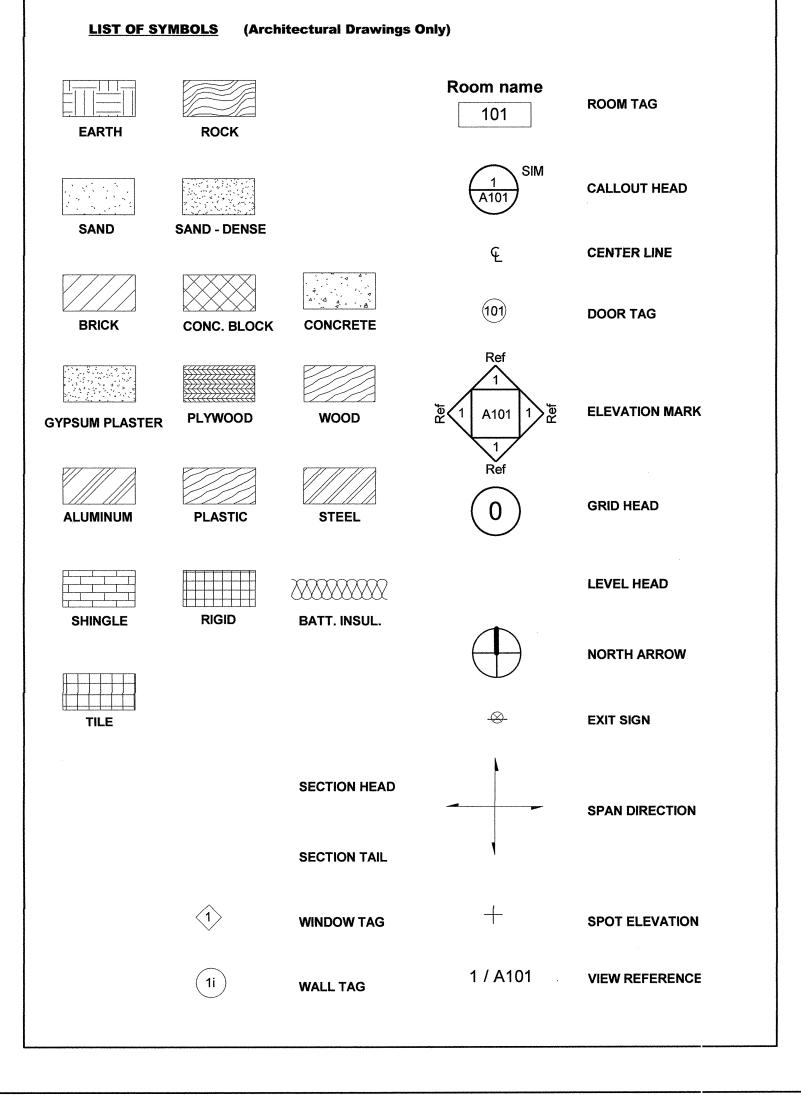



## GENERAL NOTES

- 1. CONTRACTOR SHALL ASSUME RESPONSIBILITY OF REVIEWING AND UNDERSTANDING ALL INFORMATION INCLUDED WITHIN THE CONSTRUCTION DOCUMENTS. THE CONSTRUCTION DOCUMENTS ARE AN AID TO THE CONTRACTOR IN UNDERSTANDING THE WORK AND SHOULD NOT BE CONSTRUCTED AS BEING COMPLETE IN EVERY DETAIL. IT IS THE EXPLICIT AND SPECIFIC RESPONSIBILITY OF THE CONTRACTOR TO VISIT THE SITE, VERIFY EXISTING CONDITIONS, FAMILIARIZE HIMSELF THOROUGHLY WITH THE SCOPE OF WORK AND REPORT ALL DISCREPANCIES BETWEEN THE DRAWINGS AND THE ASSUMED OR ACTUAL CONDITIONS TO THE ATTENTION OF THE DESIGNER.
- 2. MODIFICATIONS OF DESIGN OR DETAILS INCLUDED WITHIN THESE DOCUMENTS SHALL NOT BE PERMITTED WITHOUT CONSENT OF BOTH OWNER AND DESIGNER.
- 3. PLAN DIMENSIONS ARE TO FACE OF FRAMING UNLESS OTHERWISE NOTED.

  <u>DO NOT SCALE DRAWINGS IN FIELD.</u>
- 4. ALL REFERENCES TO DIMENSIONS OF FLOOR LINE ARE TAKEN FROM TOP OF CONCRETE OR UNDERLAYMENT.
- 5. CONTRACTOR'S SUPERVISOR SHALL BE PRESENT ON JOB AT ALL TIMES WHILE CONSTRUCTION WORK IS IN PROGRESS. NO WORK SHALL COMMENCE WITHOUT THEIR SUPERVISION.
- 6. CONTRACTOR SHALL LOCATE ALL EXISTING UNDERGROUND AND OVERHEAD UTILITY SERVICE ON SITE PRIOR TO COMMENCEMENT OF ANY DEMOLITION OR EXCAVATION WORK.
- 7. CONTRACTOR SHALL MAINTAIN ALL REQUIRED LOCAL FIRE DEPARTMENT VEHICLE AND EQUIPMENT ACCESS AND CLEARANCES.
- 8. CONTRACTOR SHALL PROVIDE AND MAINTAIN SECURITY OF BUILDING, CONSTRUCTION MATERIALS, FIXTURES, AND APPLIANCES DURING AND AFTER WORK HOURS.
- 9. CONTRACTOR SHALL MAINTAIN A NEAT AND ORDERLY CONSTRUCTION SITE, PROVIDING CLEAR ACCESS TO EXITS AND EGRESS PATHS FROM OWNER OCCUPIED AREAS DURING ALL PHASES OF CONSTRUCTION.
- 10. CONTRACTOR SHALL CONSULT WITH OWNER AND DESIGNER REGARDING FINAL LOCATIONS OF ALL LIGHT FIXTURES, SWITCHES, RECEPTACLES, AND OTHER MECHANICAL OR ELECTRICAL ITEMS PRIOR TO INSTALLATION.
- 11. ALL PLUMBING, MECHANICAL, AND ELECTRICAL DEMOLITION AND INSTALLATIONS SHALL BE PERFORMED BY CERTIFIED CONTRACTORS TO THE TRADE, AND SHALL BE DONE IN ACCORDANCE WITH ALL APPLICABLE STATE AND LOCAL CODES.
- 12. ALL "AS-BUILT" WORK SHALL BE ELIGIBLE FOR AND CONSISTENT WITH ALL LOCALLY REQUIRED OCCUPANCY, USE, AND ZONING PERMITS.

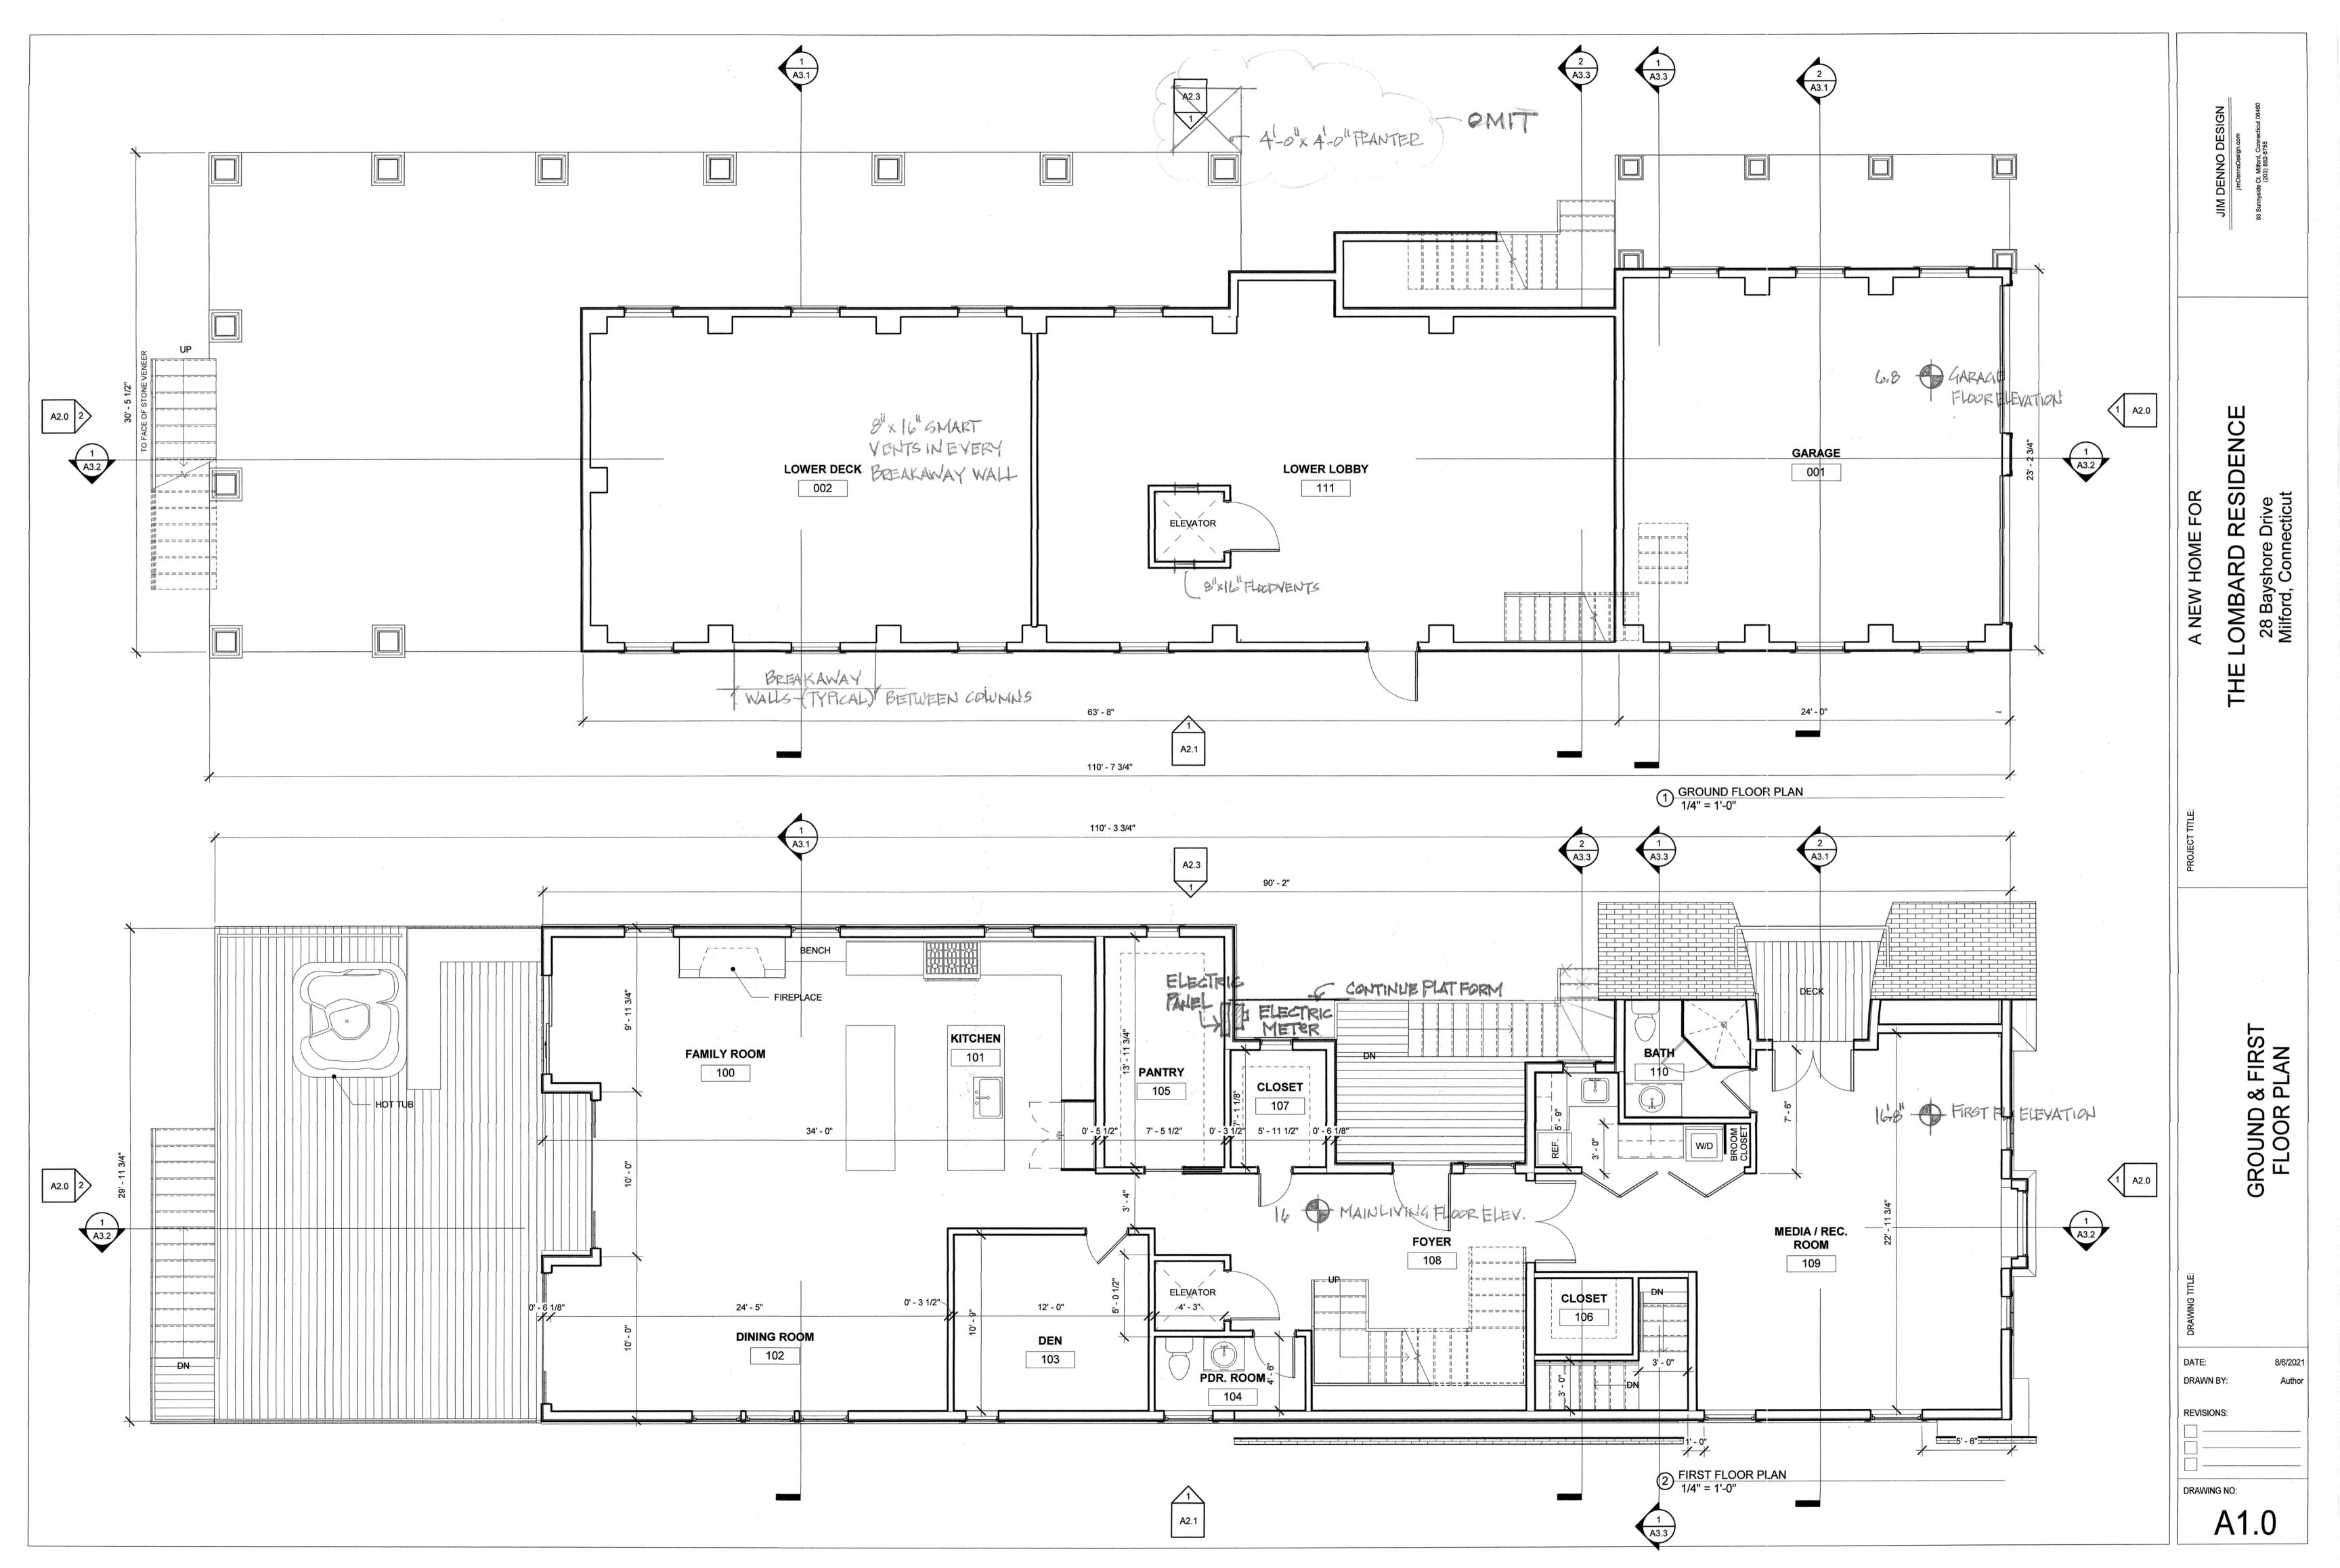

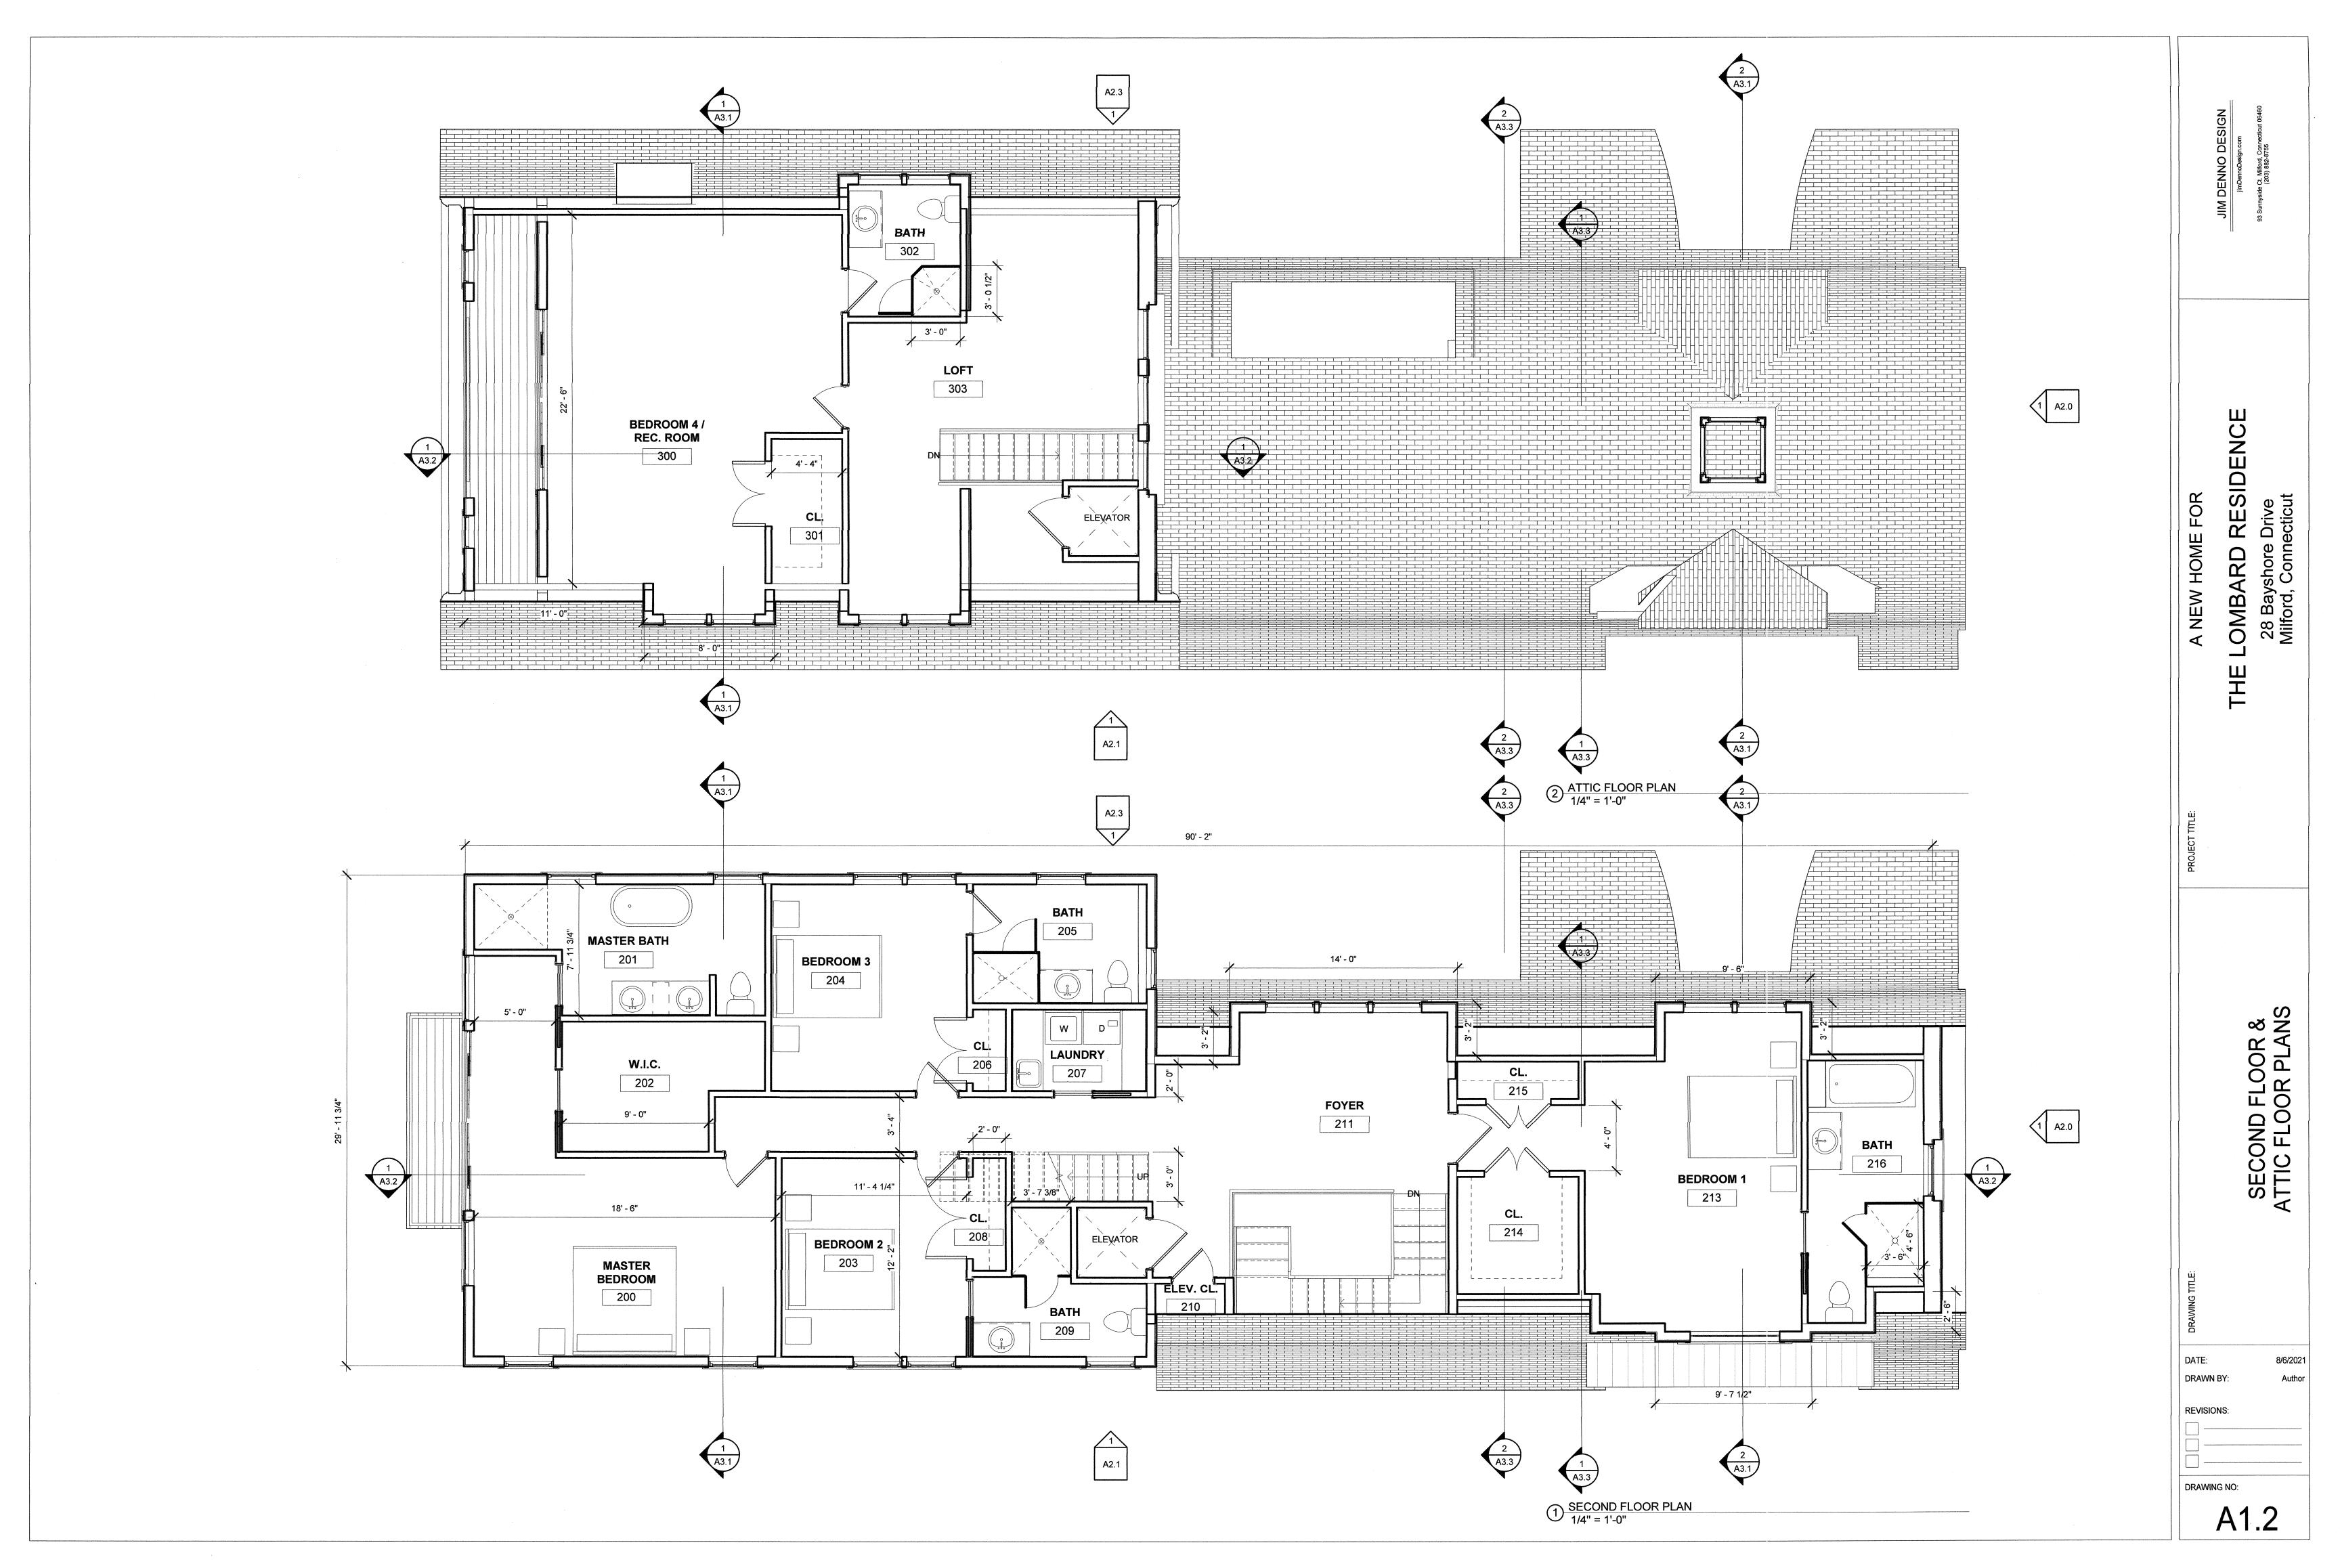

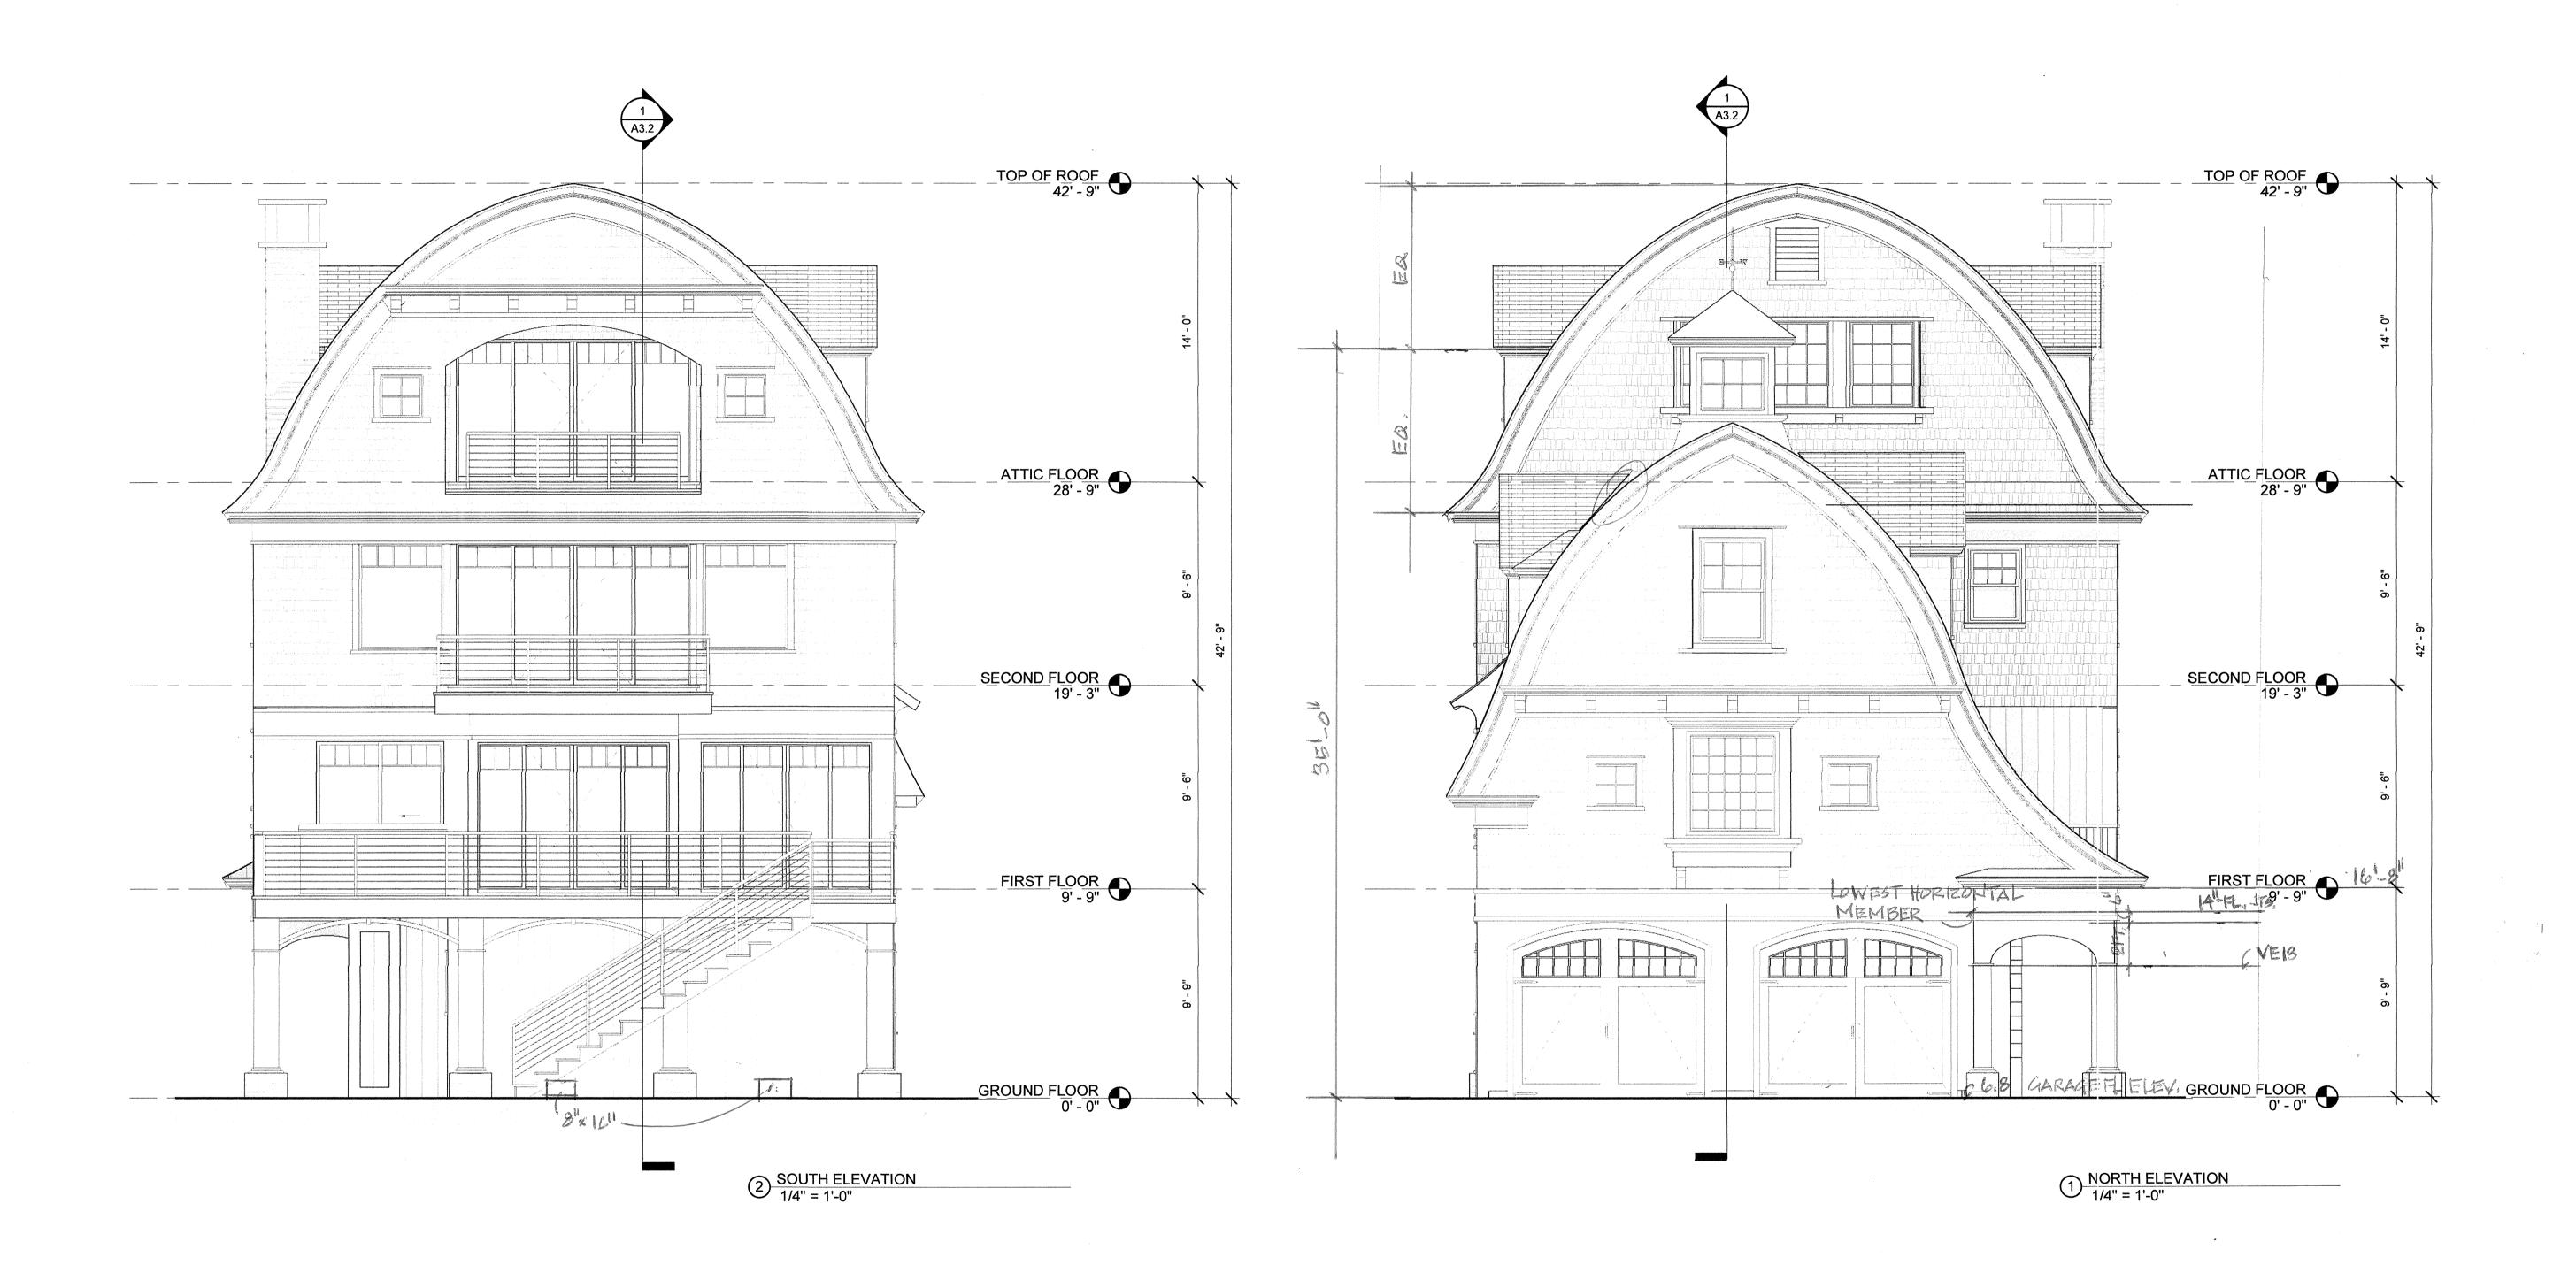

PROJECT TÎTLE:

A NEW HOME FOR

JIM DENNC

THE LOMBARD RESIDENCE

28 Bayshore Drive
Milford, Connecticut

ELEVATIONS

TITLE:

DYAMING DYAMING DATE:

DATE:
DRAWN BY:
REVISIONS:

DRAWING NO:

8/6/2021

Author

A2.0

