SUBMISSION TO THE CITY OF MILFORD PLANNING AND ZONING DEPARTMENT FOR SITE PLAN REVIEW

COLONIAL TOYOTA "SERVICE CENTER" BUILDING EXPANSION


470 BOSTON POST ROAD MILFORD, CONNECTICUT

TAX ASSESSOR MAP 064, BLOCK 930, PARCEL 9
ZONE: CORRIDOR DESIGN DEVELOPMENT DISTRICT 1 (CDD-1)


MARCH 9, 2022 (REVISED AUGUST 18, 2022)

LIST OF DRAWINGS
TIOL OF DIVENDING

SHEET	IIILE	DATE	REVISED
	COVER SHEET	03/09/2022	07/29/2022
1 of 1	PROPERTY TOPOGRAPHIC SURVEY	05/21/2022	-
1 of 1	LIMITED TOPOGRAPHIC SURVEY	12/21/2021	-
OS-1	OVERALL SITE PLAN	09/08/2021	07/29/2022
G-1	GENERAL NOTES	03/09/2022	07/29/2022
X-1	EXISTING CONDITIONS PLAN	03/09/2022	07/29/2022
C-1	SITE PLAN	03/09/2022	07/29/2022
C-2	GRADING PLAN	03/09/2022	07/29/2022
C-3	UTILITIES PLAN	03/09/2022	07/29/2022
ES-1	SOIL EROSION AND SEDIMENTATION CONTROL PLAN	03/09/2022	07/29/2022
ES-2	SOIL EROSION AND SEDIMENTATION CONTROL NARRATIVE AND DETAILS	03/09/2022	07/29/2022
L-1	OVERALL LANDSCAPE PLAN	07/01/2022	08/18/2022
L-2	COURTYARD PLAN AND DETAILS	07/01/2022	08/18/2022
CD-1	CONSTRUCTION DETAILS	03/09/2022	07/29/2022
CD-2	CONSTRUCTION DETAILS	03/09/2022	07/29/2022
CD-3	CONSTRUCTION DETAILS	03/09/2022	07/29/2022
A-1	NEW BUILDING FLOOR PLAN	06/23/2022	07/29/2022
A-2.0	NEW BUILDING EXTERIOR FRONT & REAR ELEVATIONS	06/23/2022	07/29/2022
A-2.1	NEW BUILDING EXTERIOR SIDE & INTERIOR ELEVATIONS	06/23/2022	07/29/2022

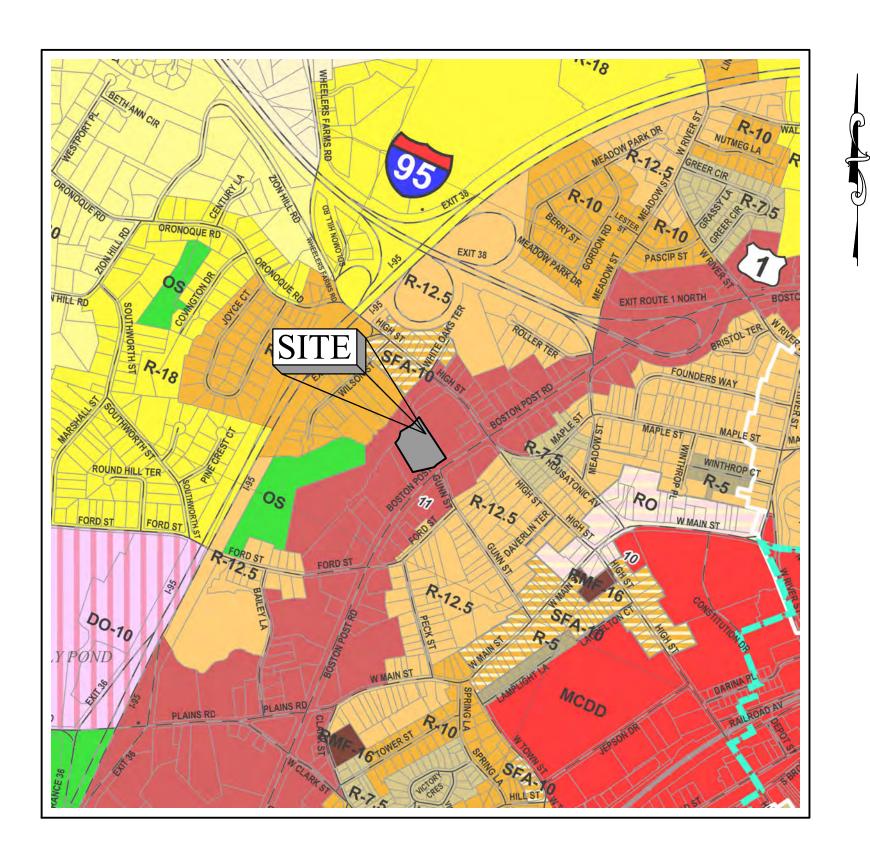

SITE LOCATION MAP

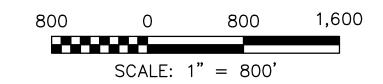

PROPERTY OWNER

GOLD COAST REALTY LLC 470 Boston Post Road Milford, CT 06460

Contact Name: Robert E. Crabtree Jr. Telephone: (203) 231-3103 Email: Rcrabtree@colonialtoyotact.com

ARCHITECTURAL SERVICES

JOHN RUFFALO III ARCHITECTS

415 Howe Avenue, Suite 302 Shelton, CT 06484

Contact Name: John Ruffalo III Telephone: (203) 924-2272 Email: ruffaloarch@mags.net


CIVIL ENGINEERING AND SURVEYING SERVICES





142 Temple Street, Suite 202 New Haven, CT 06510

Contact Name: Raymond G. Paier, P.E. Telephone: (203) 789-1260 E-mail: rpaier@westcottandmapes.com

W&M Project No. 21-090-10

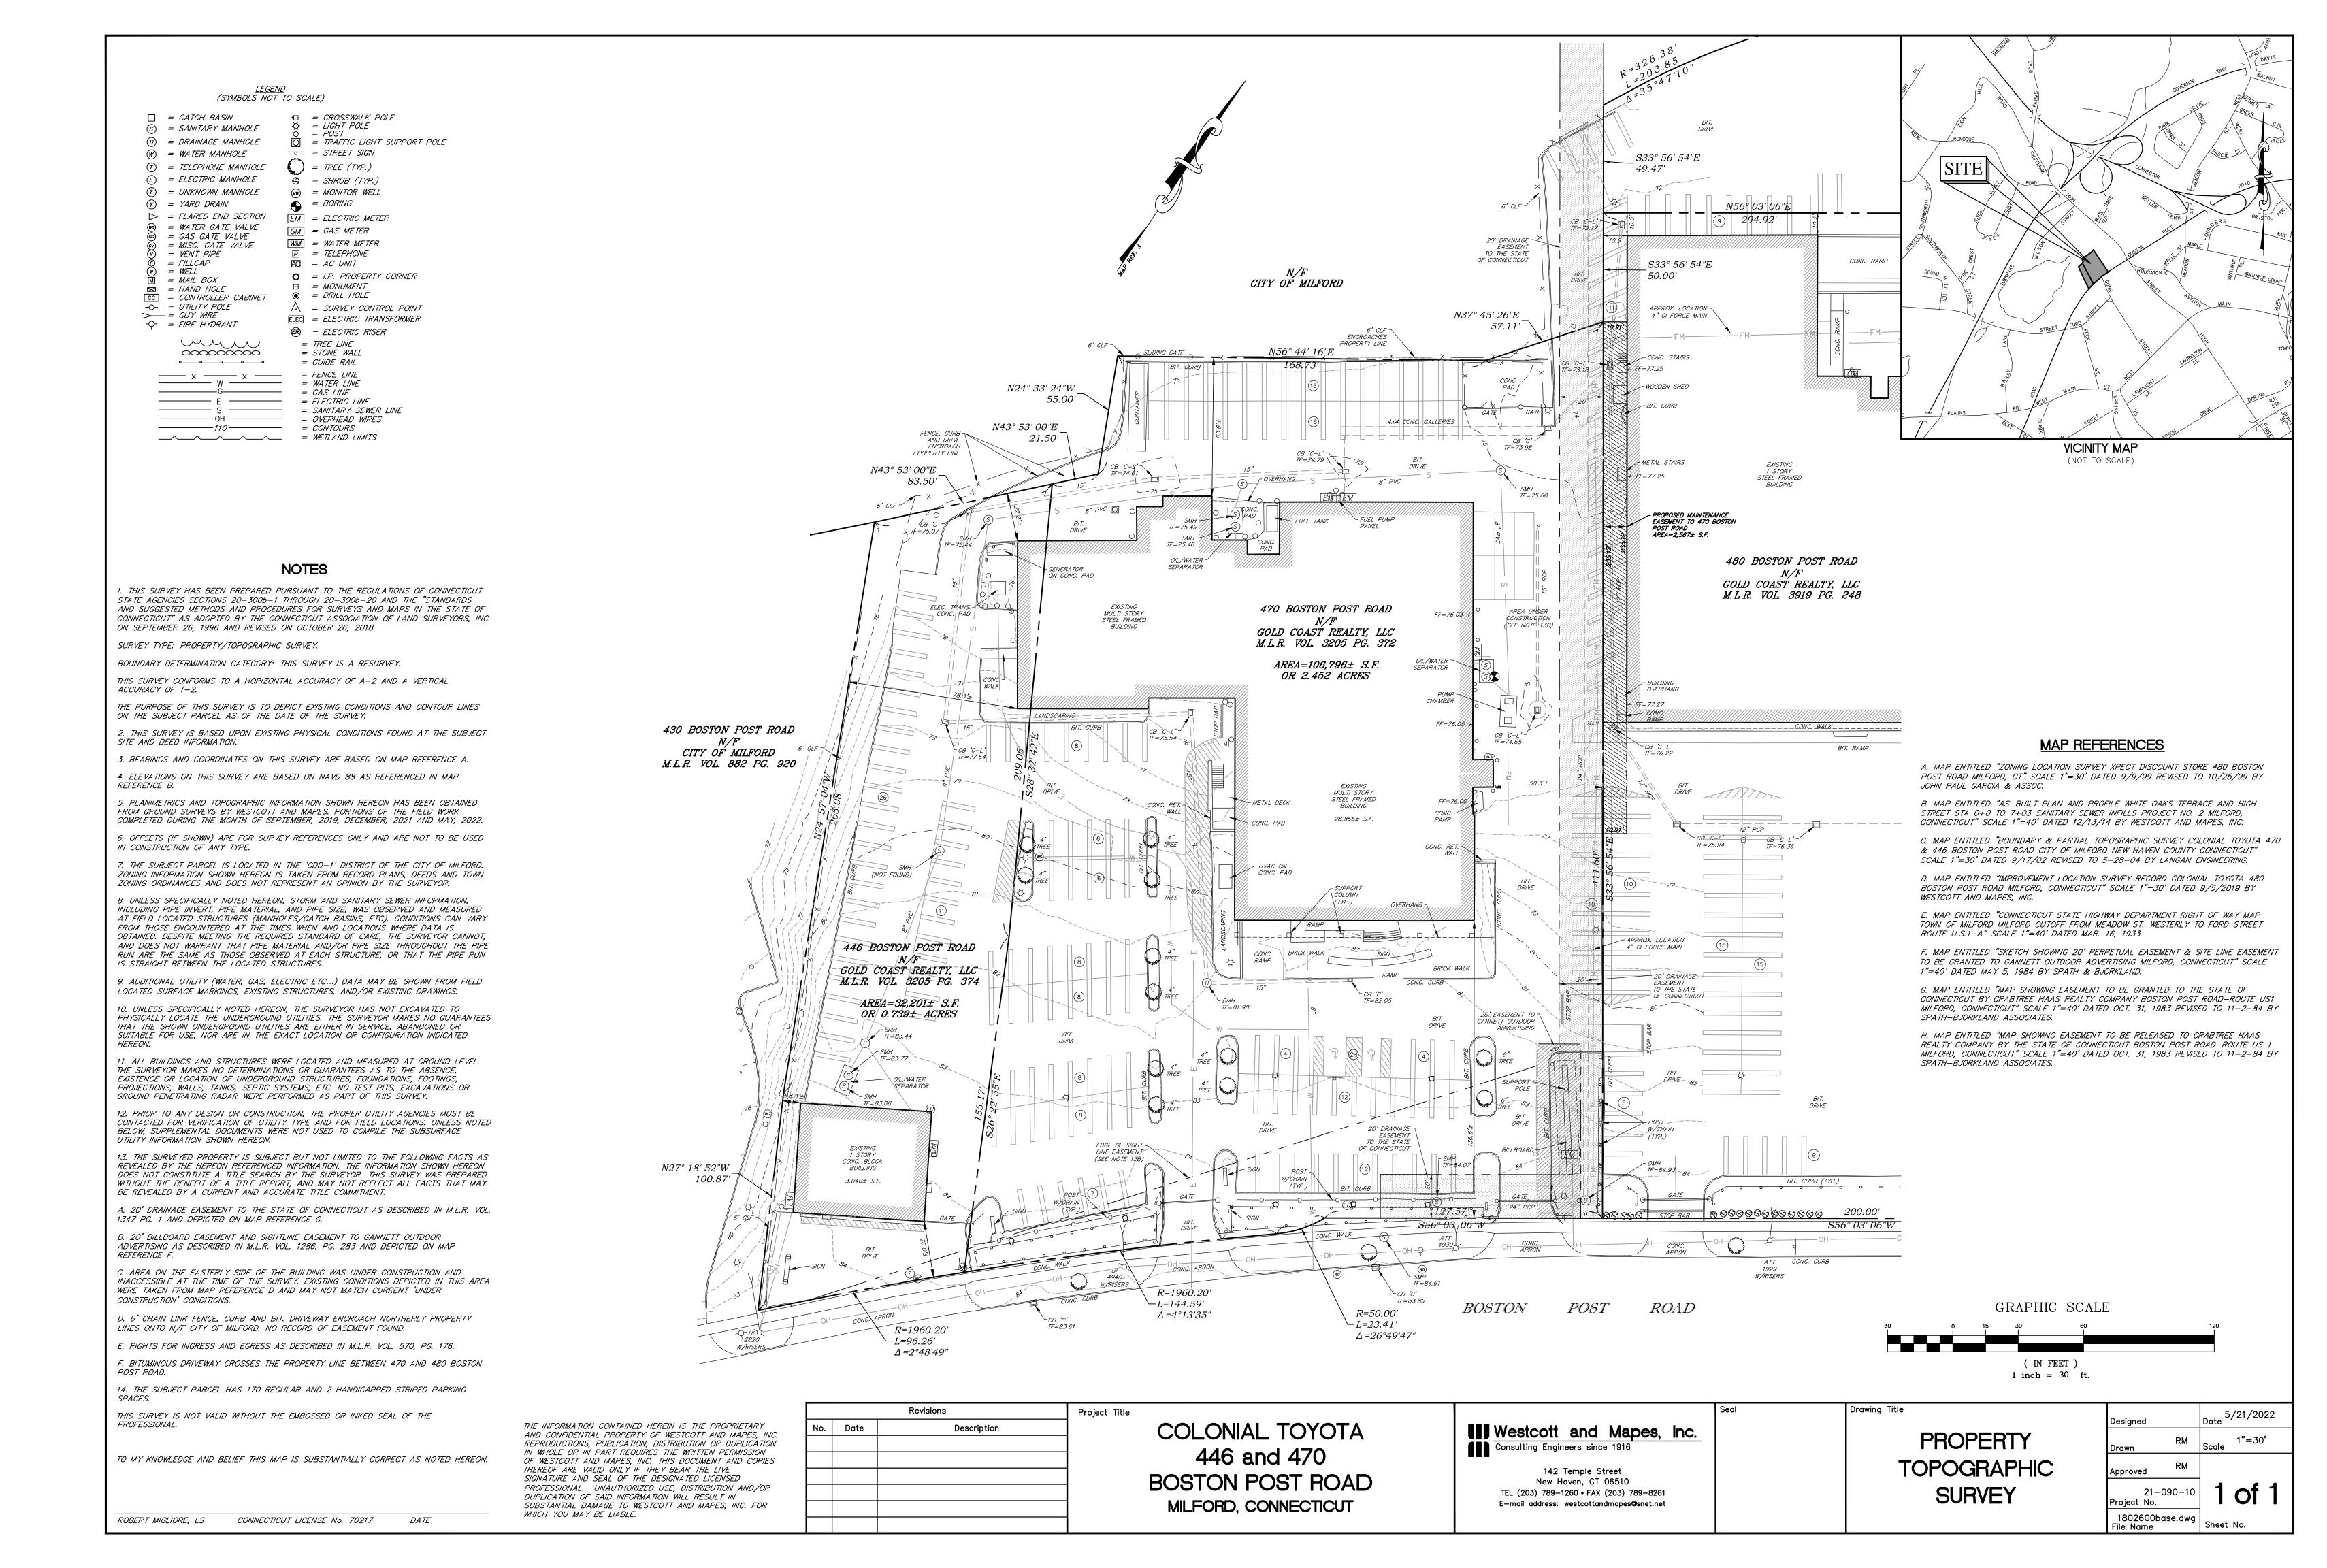

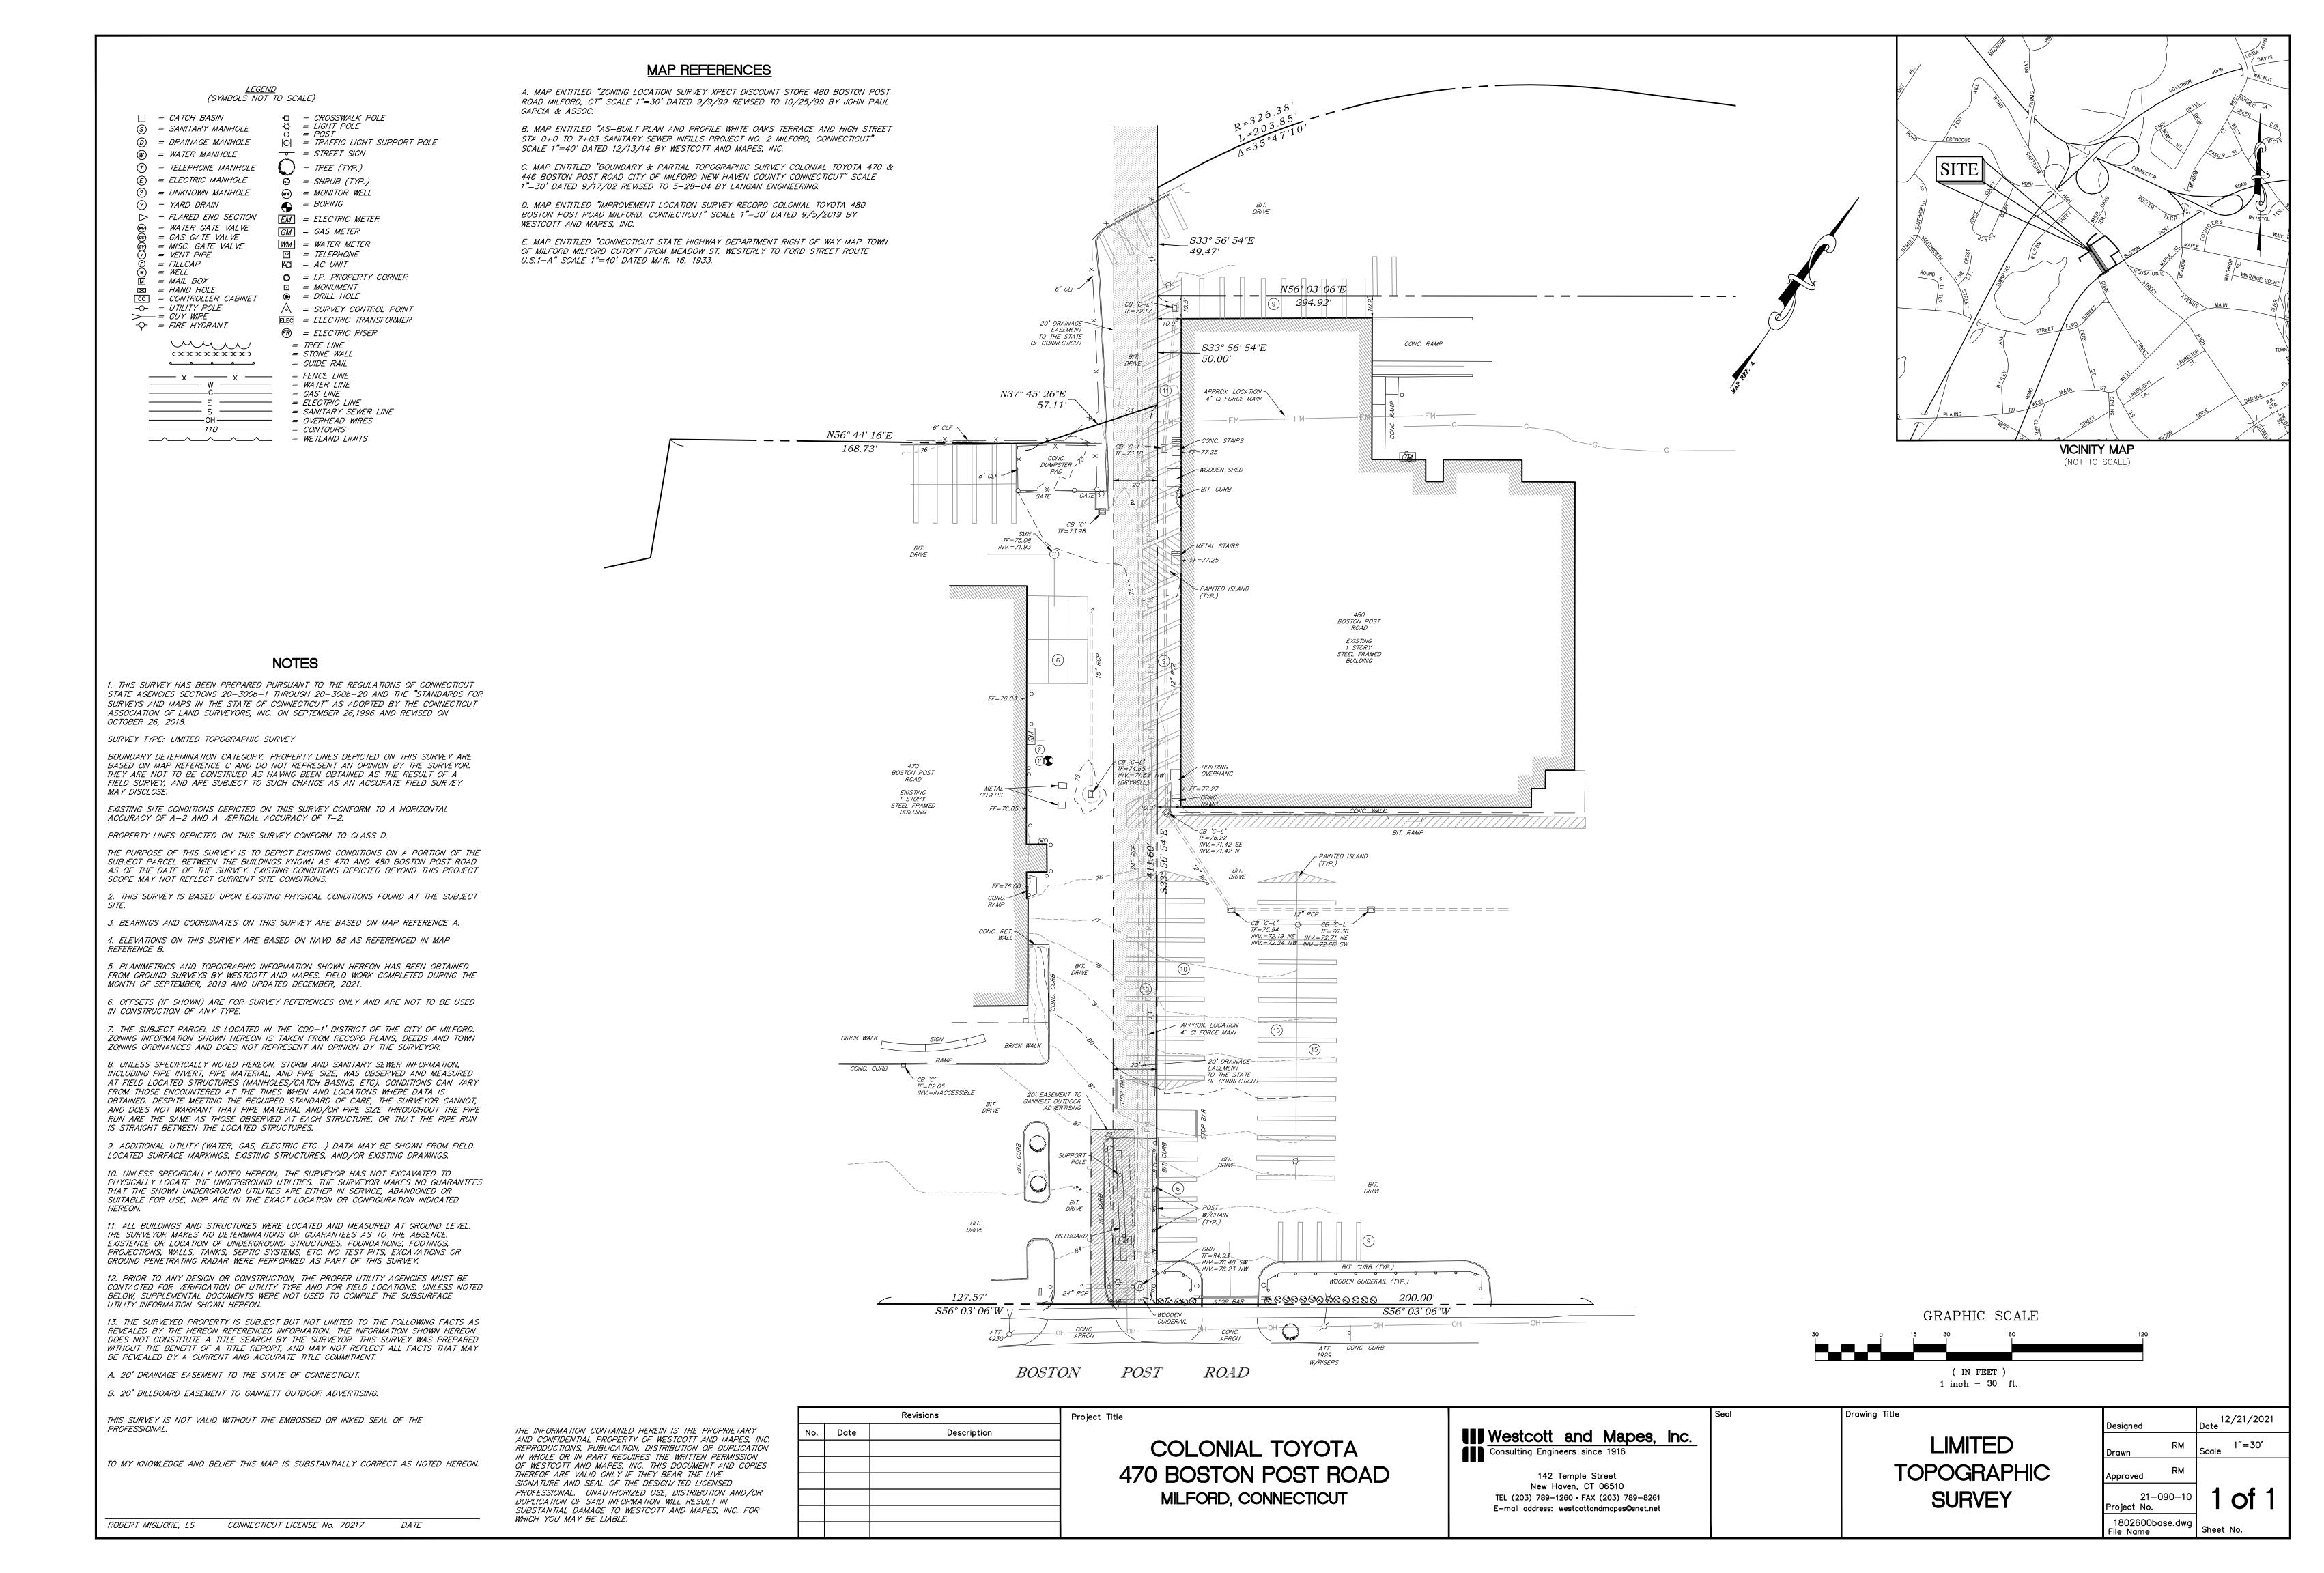

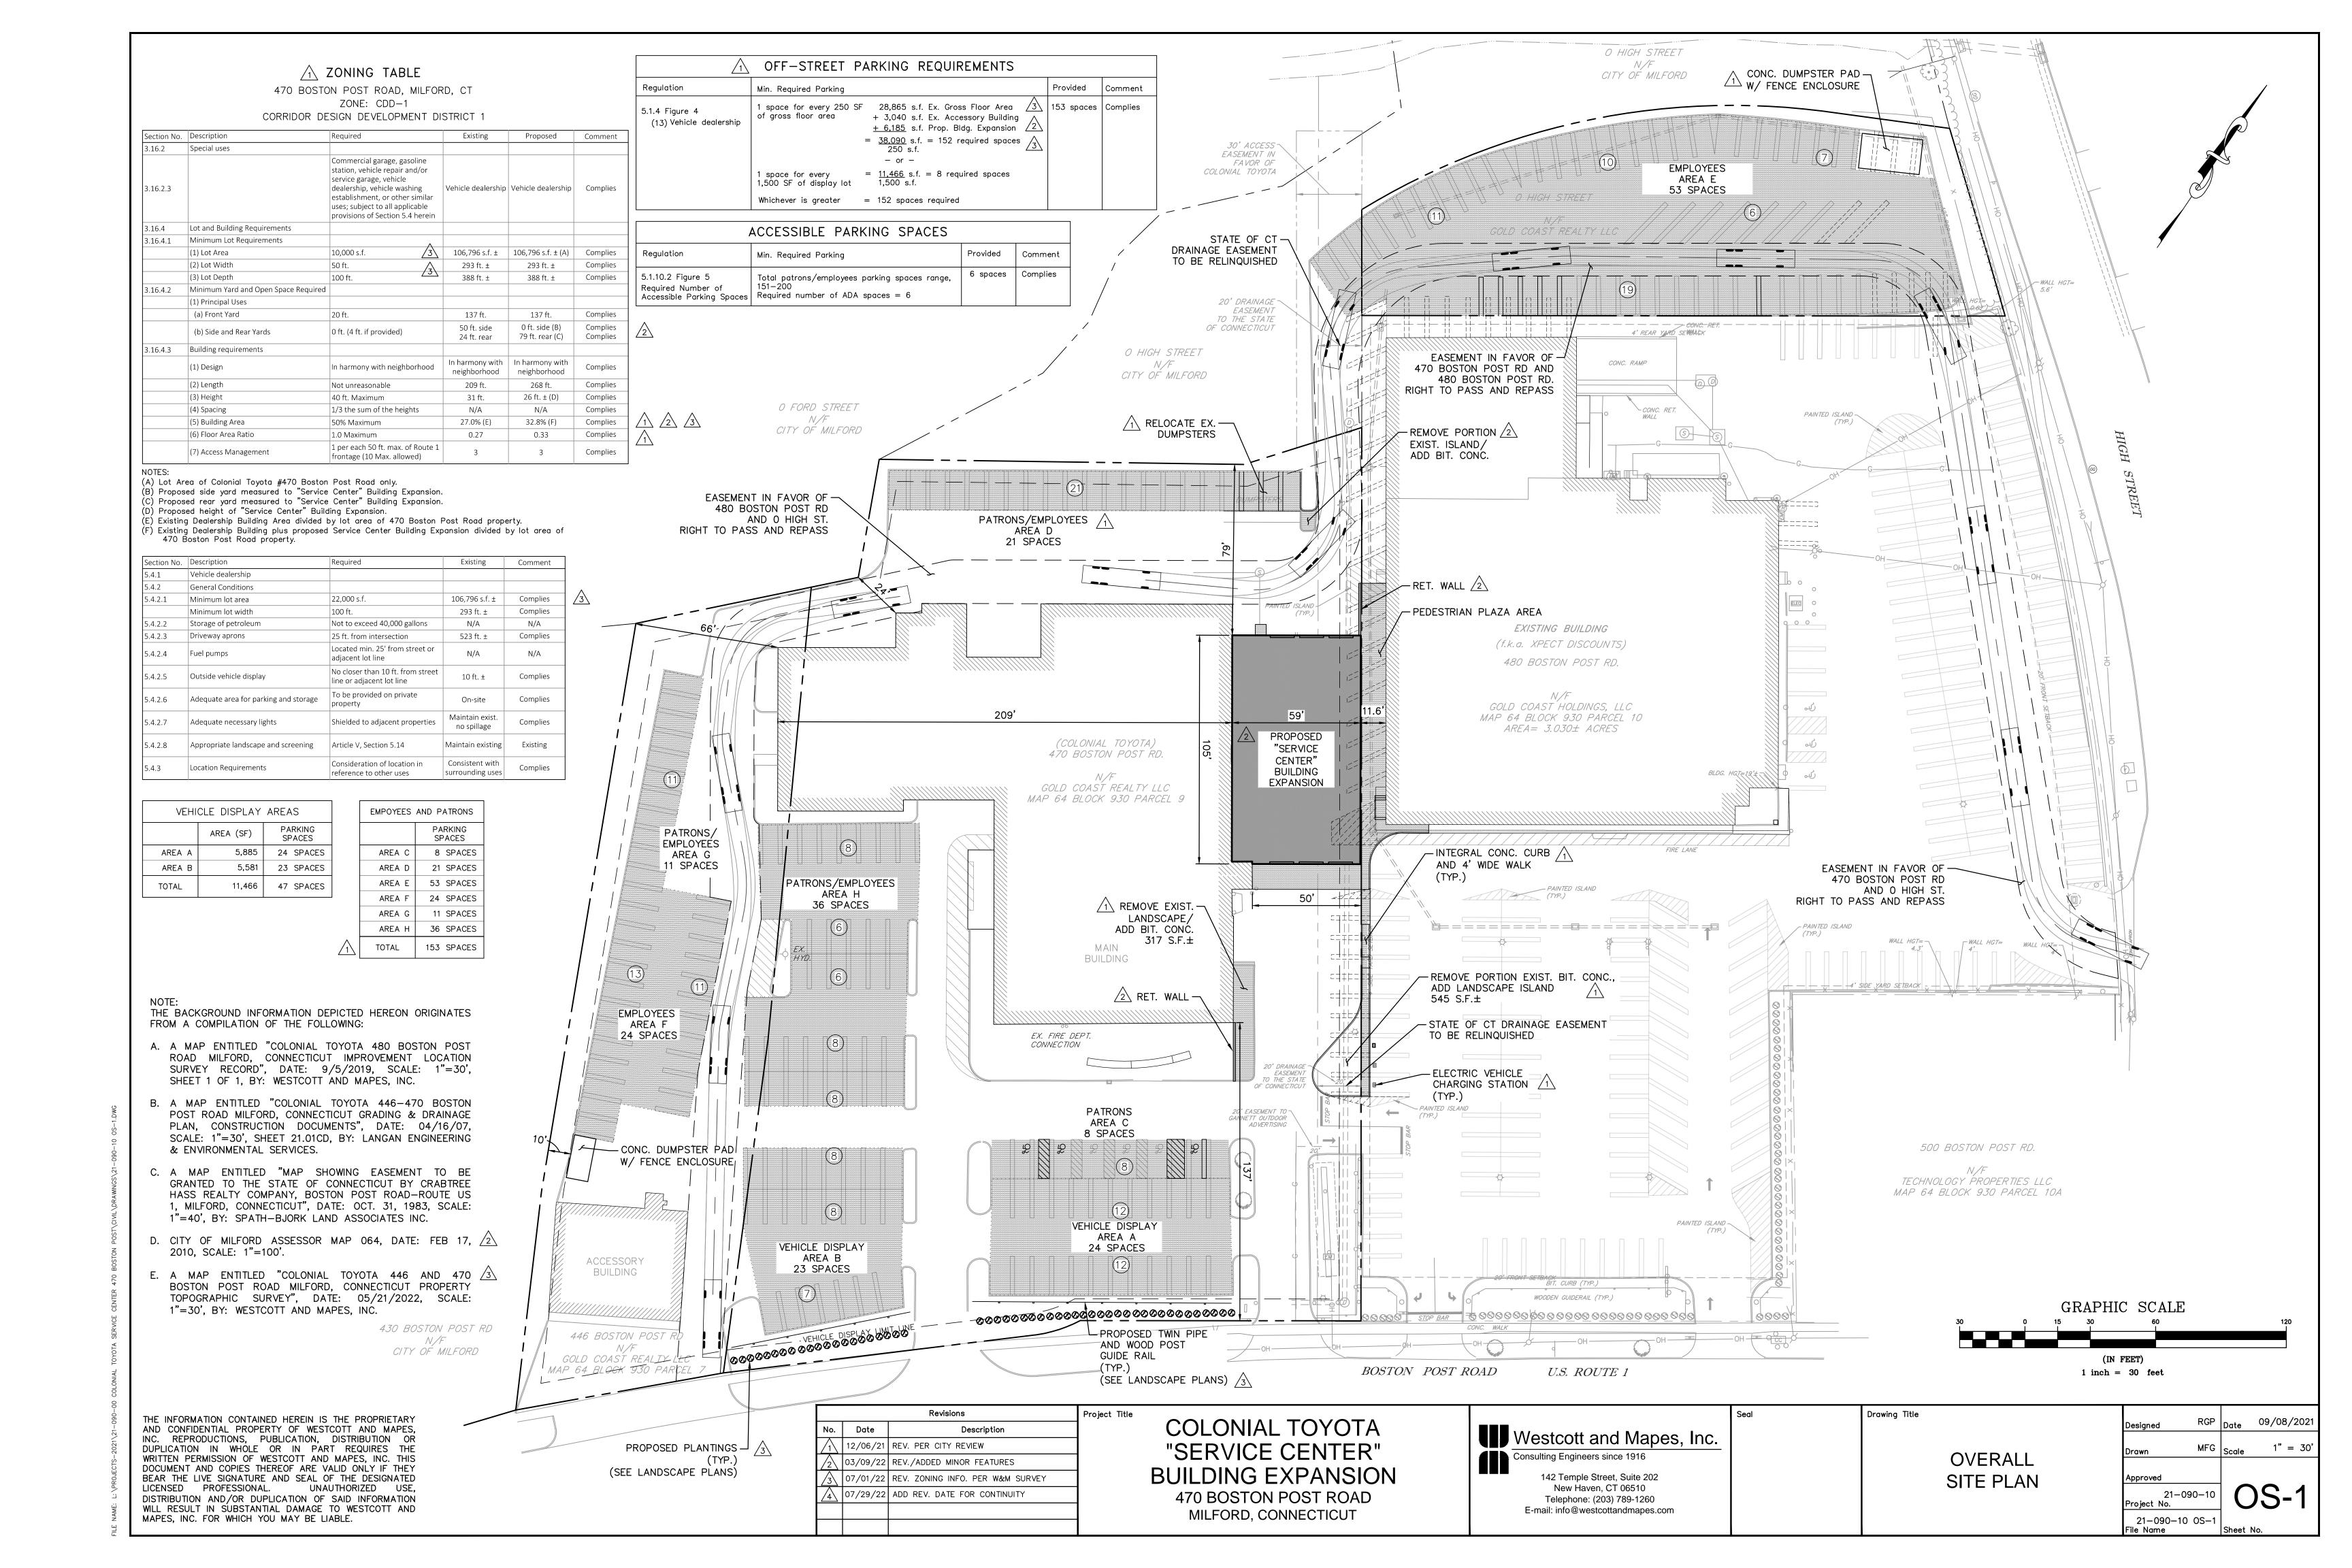

Revisions No. Date Description 07/01/22 ADDED REV. DATE FOR CONTINUITY 07/29/22 ADDED REV. DATE FOR CONTINUITY

RGP | Date 03/09/2022 Approved 21-090-10

21-090-10 CIVIL

GENERAL NOTES

GENERAL NOTES

DENOTED ON THESE PLANS.

ACTIVITIES.

SPECIFIC UTILITY PROVIDER.

INSTALLATION OF NEW WORK.

OPERATIONS WITH THE PROPERTY OWNER.

CONTRACTOR SHALL CONTACT THE ENGINEER.

PROPER/ACCEPTABLE RECEIVING FACILITY.

2020 AND AS AMENDED.

2. THE VERTICAL DATUM OF THIS PLAN SET IS NAVD '88.

INVESTIGATION PRIOR TO COMMENCEMENT OF HIS WORK.

SEDIMENT CONTROL MANUAL, LATEST EDITION.

HOURS PRIOR TO COMMENCING WORK.

1. THE PURPOSE OF THIS PLAN SET IS TO PROVIDE THE CIVIL/SITE ENGINEERING AND ARCHITECTURAL INFORMATION FOR SUBMISSION TO THE CITY OF MILFORD FOR SITE PLAN REVIEW.

3. THE CONTRACTOR SHALL MAINTAIN ALL OF HIS OPERATIONS AND WORK WITHIN THE AREAS

4. THE CONTRACTOR SHALL FAMILIARIZE HIMSELF WITH THE SITE CONDITIONS AND PERFORM A FIELD

5. THE CONTRACTOR SHALL INSTALL AND MAINTAIN TEMPORARY EROSION AND SEDIMENTATION CONTROL MEASURES WHERE APPLICABLE, THROUGHOUT THE PROJECT DURATION, IN ACCORDANCE WITH THIS PLAN SET AND WITH THE STATE OF CONNECTICUT GUIDELINES FOR SOIL EROSION AND

6. THE CONTRACTOR SHALL CONTACT 811 "CALL BEFORE YOU DIG" AT LEAST SEVENTY-TWO (72)

7. EXISTING UTILITIES MAY BE SHOWN ACCORDING TO REFERENCE PLANS WHEN AVAILABLE,

8. THE CONTRACTOR SHALL DIG TEST PITS WHERE NECESSARY TO DETERMINE THE LOCATION, DEPTH, SIZE, AND MATERIAL OF BURIED UTILITIES AND OTHER FEATURES IN THE AREA OF HIS INTENDED WORK TO DETERMINE IF ANY POTENTIAL CONFLICTS MAY OCCUR, PRIOR TO CONSTRUCTION. THE CONTRACTOR SHALL ACCURATELY DOCUMENT THE EXISTING INFORMATION IN WRITING AND SHALL

9. THE CONTRACTOR IS SOLELY RESPONSIBLE FOR COORDINATING ALL WORK REGARDING THIS PROJECT AND FOR OBTAINING ANY NECESSARY PERMITS RELATED TO HIS CONSTRUCTION

10. THE CONTRACTOR IS RESPONSIBLE FOR COORDINATING WITH ALL APPLICABLE AGENCIES AND UTILITY COMPANIES, AS NECESSARY, FOR PROJECT COMPLETION. THE CONTRACTOR SHALL PERFORM ALL UTILITY RELOCATION WORK IN ACCORDANCE WITH THE REQUIREMENTS OF THE

11. THE CONTRACTOR SHALL BE RESPONSIBLE FOR ESTABLISHING AND MAINTAINING A SAFE ENVIRONMENT FOR WORKERS, PEDESTRIANS, AND VEHICULAR TRAFFIC THROUGHOUT THE CONSTRUCTION PERIOD, AND COORDINATE HIS EFFORTS AND HIS SEQUENCE AND TIMING OF

12. THE CONTRACTOR IS RESPONSIBLE FOR THE PROPER DEMOLITION, REMOVAL, AND OFF-SITE DISPOSAL OF EXISTING FEATURES, WITHIN THE LIMITS OF WORK, AS REQUIRED FOR THE

13. ANCILLARY OR OTHER EXISTING FEATURES MAY EXIST WHICH ARE NOT SPECIFICALLY IDENTIFIED OR CALLED FOR DEMOLITION, ABANDONMENT, OR REMOVAL, BUT SHALL BE INCLUDED AS SUCH,

14. EXCAVATION AND CONSTRUCTION ACTIVITY SHALL BE ACCOMPLISHED IN SUCH A MANNER THAT ALL EXISTING FEATURES, UTILITIES, OR STRUCTURES THAT ARE TO REMAIN SHALL NOT BE DAMAGED. IT SHALL BE THE CONTRACTOR'S RESPONSIBILITY TO PROTECT EXISTING FEATURES TO REMAIN. IF DAMAGED, HE SHALL REPAIR OR REPLACE IN-KIND. ALL RELATED REPAIR OR

15. THE CONTRACTOR SHALL RESTORE OR REPLACE, IN KIND OF SAME MATERIAL AND QUALITY, ALL SITE ITEMS AND FEATURES REMOVED OR DISTURBED WITHIN THE LIMITS AND LOCATION OF HIS WORK THAT ARE INTENDED TO BE FINAL FEATURES. THE CONTRACTOR SHALL COORDINATE AND CONFIRM HIS RESTORATION WORK AND MATERIALS WITH THE PROPERTY OWNER PRIOR TO

EXECUTION AND SHALL OBTAIN SATISFACTION RELEASE FROM THE OWNER UPON COMPLETION.

16. IN AREAS WHERE ROCK IS ENCOUNTERED, WITHIN THE LIMITS OF WORK, THE FOLLOWING SHALL APPLY: IN PAVEMENT AREAS, ROCK SHALL BE REMOVED TO A MINIMUM DEPTH OF 20" BELOW THE FINISH GRADE OF THE PAVEMENT; IN AREAS OF STORM DRAINAGE AND/OR RETENTION STRUCTURES, ROCK SHALL BE REMOVED TO A MINIMUM DEPTH OF 24" BELOW THE BOTTOM OF THE STRUCTURE; IN AREAS OF GENERAL UTILITIES, ROCK SHALL BE REMOVED TO A MINIMUM DEPTH OF 12" BELOW THE BOTTOM OF THE PIPE; AND FOR PLANTINGS, ROCK SHALL BE REMOVED 24" AROUND/BELOW THE ROOT BALL. IF/WHERE ROCK REMOVAL IS IN QUESTION, THE

17. THE MINIMUM VERTICAL SEPARATION BETWEEN UTILITY CROSSINGS SHALL BE 12" WITH COMPACTED SUITABLE BEDDING MATERIAL BETWEEN THE UTILITIES UNLESS OTHERWISE DIRECTED BY THE

18. ALL DISTURBED AREAS OF NON-SPECIFIC SURFACE TREATMENT OR PLANTINGS SHALL RECEIVE A

19. IF GROUNDWATER AND/OR SURFACE RUN-OFF IS ENCOUNTERED AND DEWATERING BECOMES NECESSARY, MEASURES SHALL BE TAKEN TO ENSURE THE PRESERVATION OF EXISTING SOILS AND FEATURES. MEASURES SHALL INCLUDE BUT NOT BE LIMITED TO DISCHARGING WATER INTO A SUITABLE SEDIMENTATION FILTER SYSTEM, PROTECTION FROM SCOUR AND RELEASE INTO A

20. UNLESS OTHERWISE SPECIFIED, PROCEDURES, METHODS, AND MATERIALS FOR THIS PROJECT SHALL CONFORM TO THE "STATE OF CONNECTICUT DEPARTMENT OF TRANSPORTATION STANDARD SPECIFICATIONS FOR ROADS, BRIDGES, FACILITIES AND INCIDENTAL CONSTRUCTION FORM 818,

MINIMUM OF 6" OF SCREENED TOPSOIL AND GENERAL SUN/SHADE GRASS SEED MIXTURE.

AS APPROPRIATE, FOR THE PROPER SITE PREPARATION OF THE NEW WORK.

REPLACEMENT WORK SHALL BE AT THE CONTRACTOR'S OWN EXPENSE.

EXIST NOT SHOWN AND ARE UNKNOWN TO THE AUTHOR OF THESE PLANS.

NOTIFY THE OWNER AND ENGINEER OF THE OPPORTUNITY FOR FIELD OBSERVATION.

SKETCHES, TESTIMONY, AND/OR FIELD EVIDENCE AND MUST BE CONSIDERED APPROXIMATE IN NATURE. THE CONTRACTOR SHALL CONFIRM ACTUAL LOCATIONS AND ELEVATIONS OF EXISTING UTILITIES IF AND WHERE NECESSARY. THERE MAY BE OTHER FEATURES AND/OR UTILITIES THAT

Drawing Title COLONIAL TOYOTA Westcott and Mapes, Inc. "SERVICE CENTER" Consulting Engineers since 1916 **BUILDING EXPANSION** 142 Temple Street, Suite 202 New Haven, CT 06510 470 BOSTON POST ROAD Telephone: (203) 789-1260 E-mail: info@westcottandmapes.com MILFORD, CONNECTICUT

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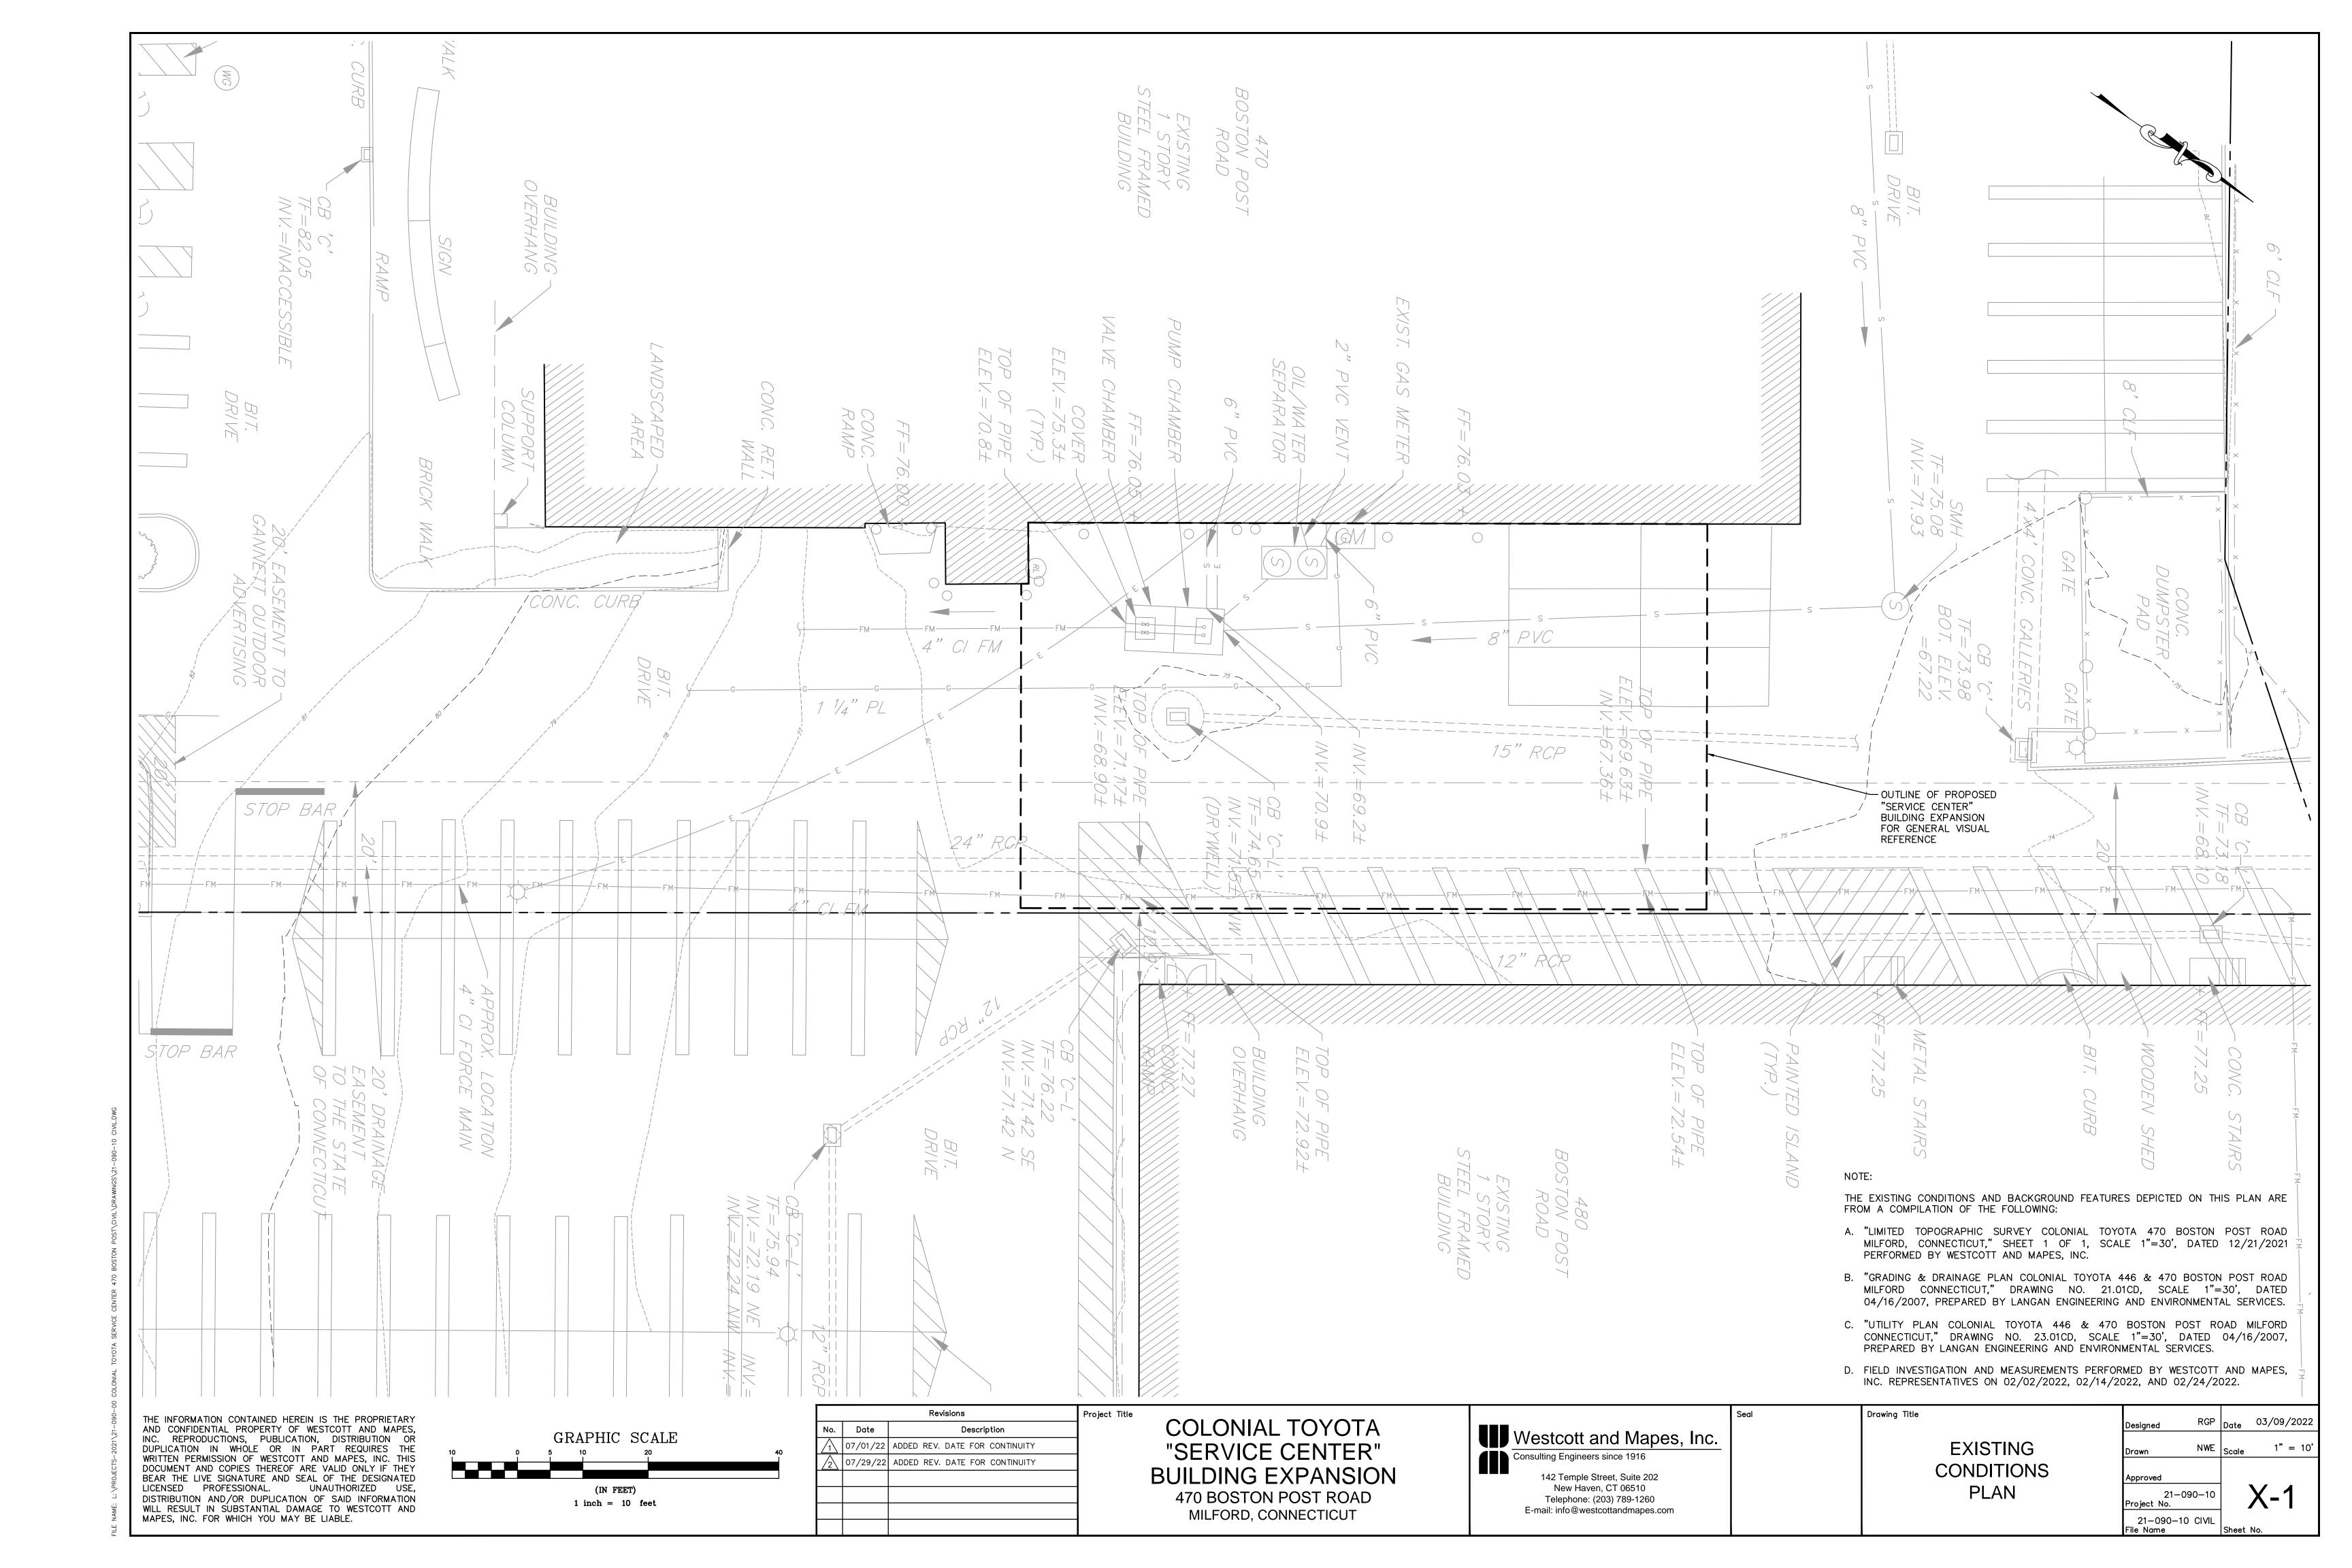
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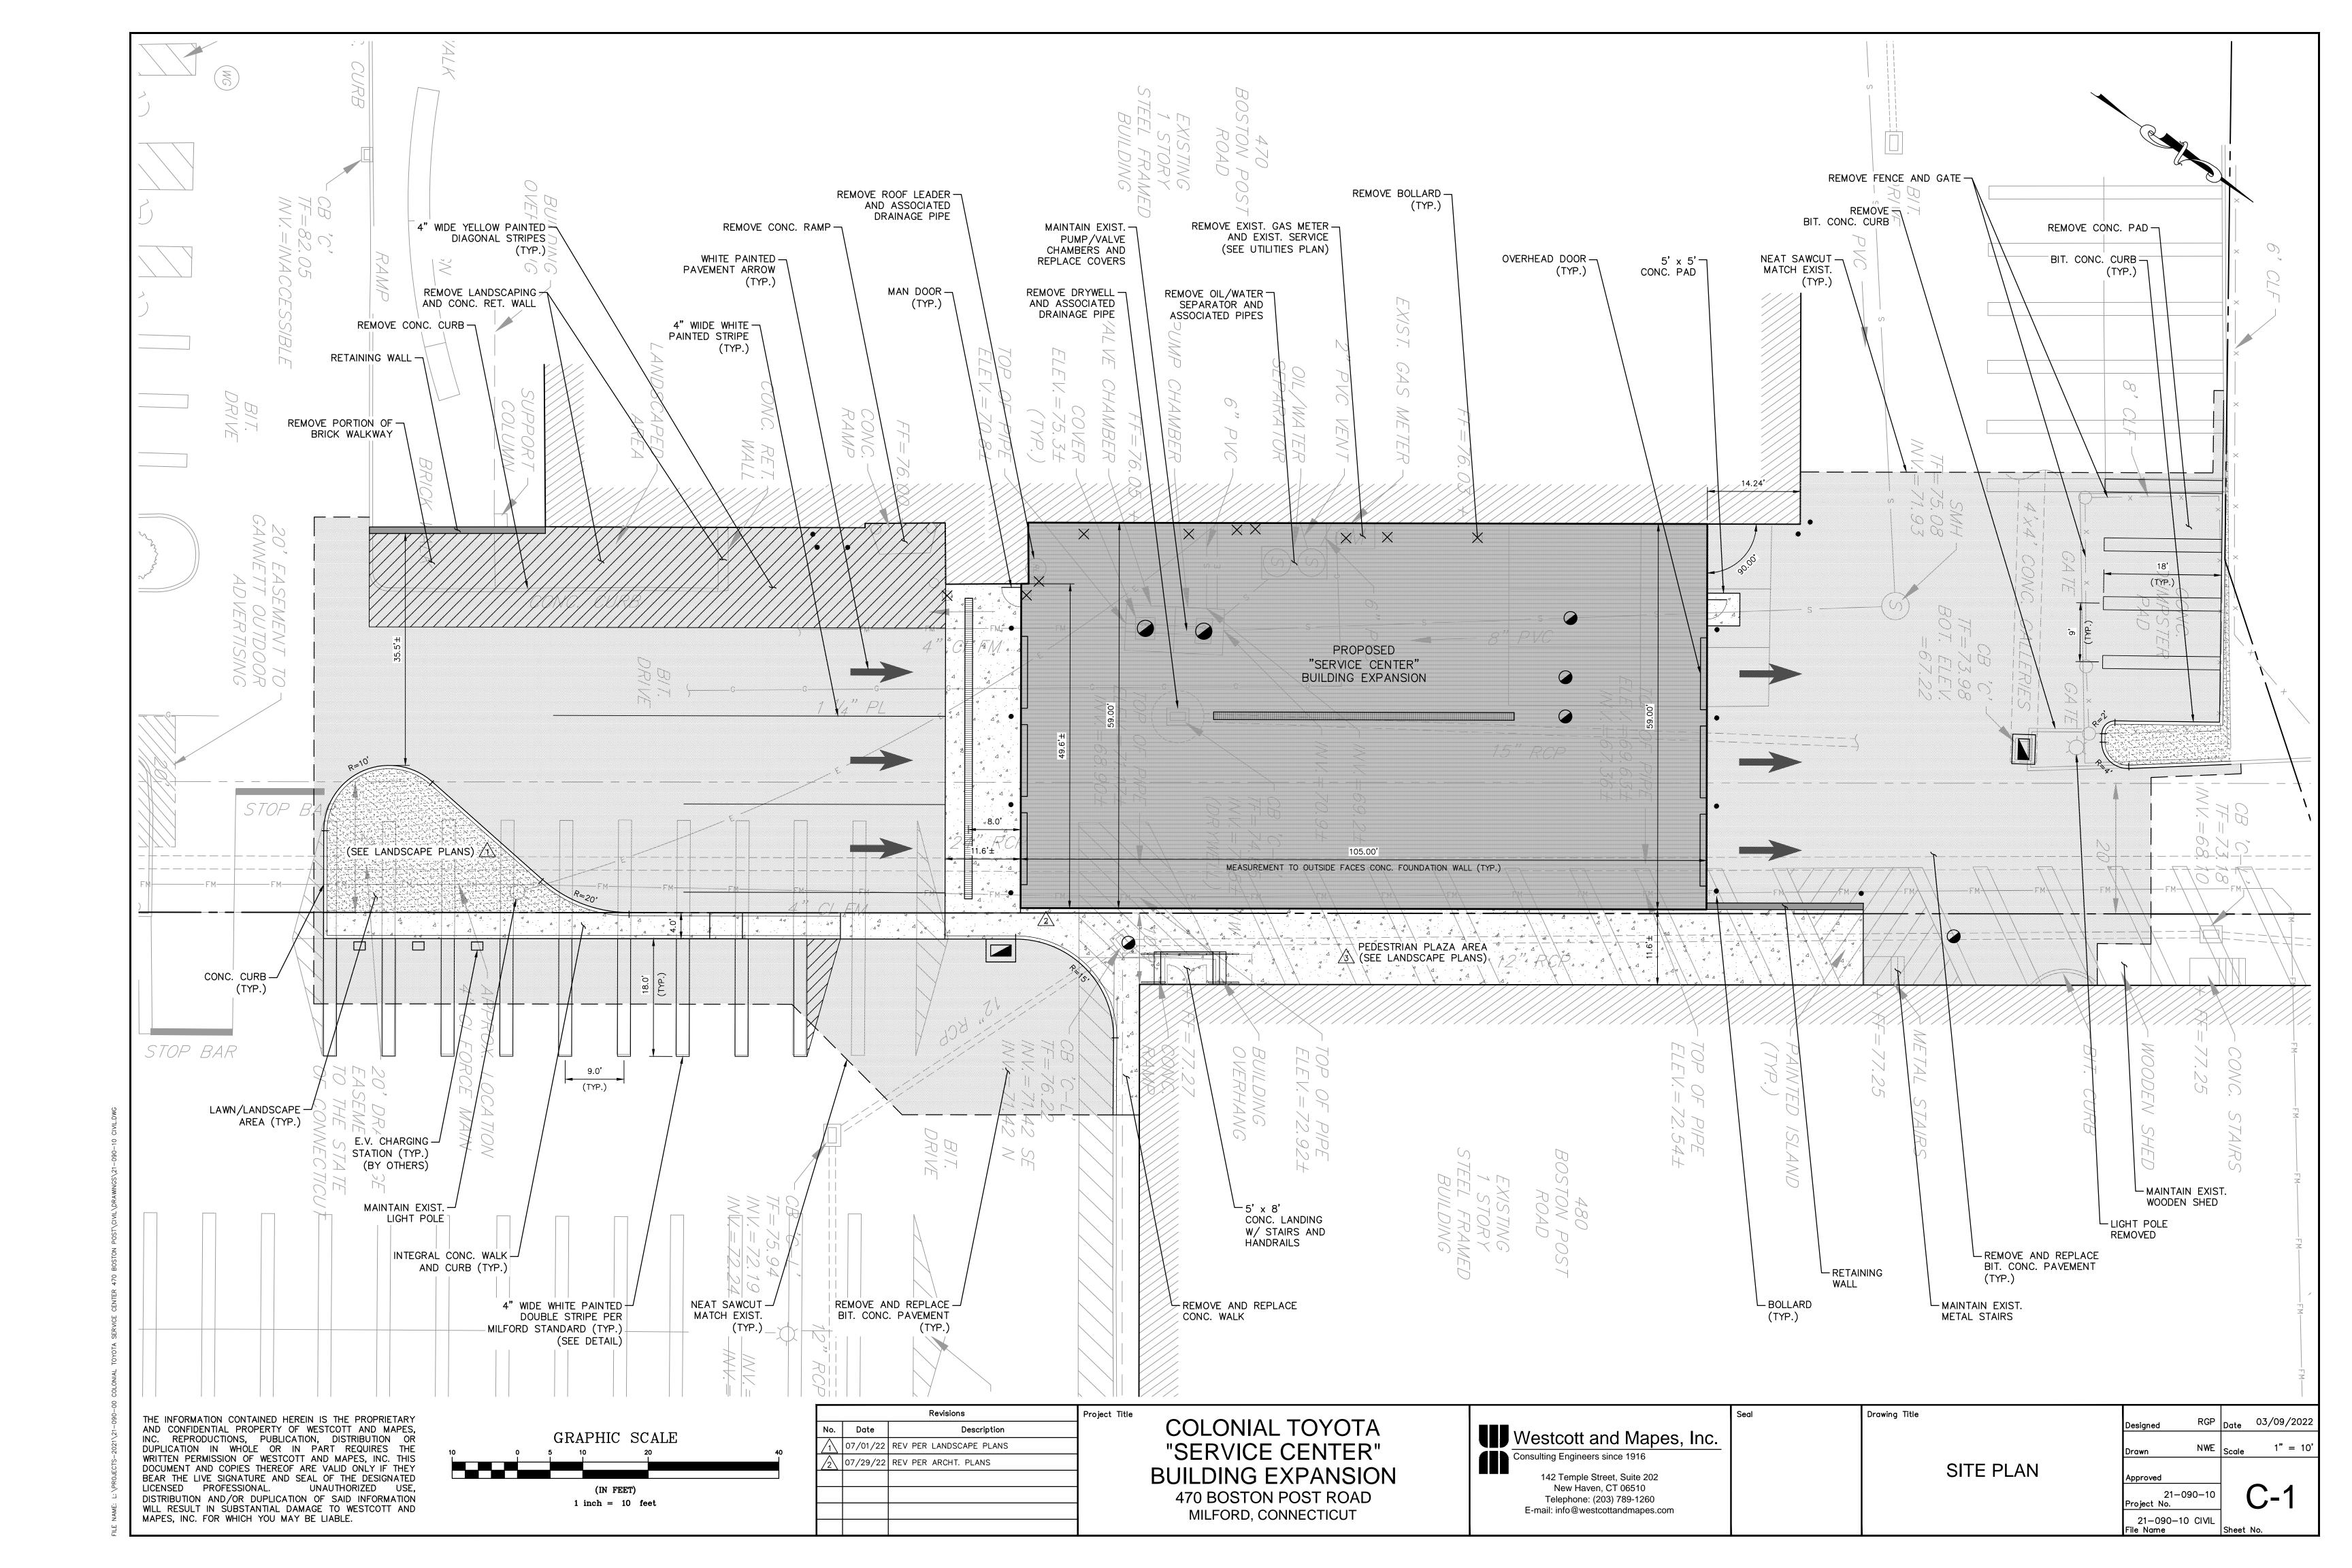
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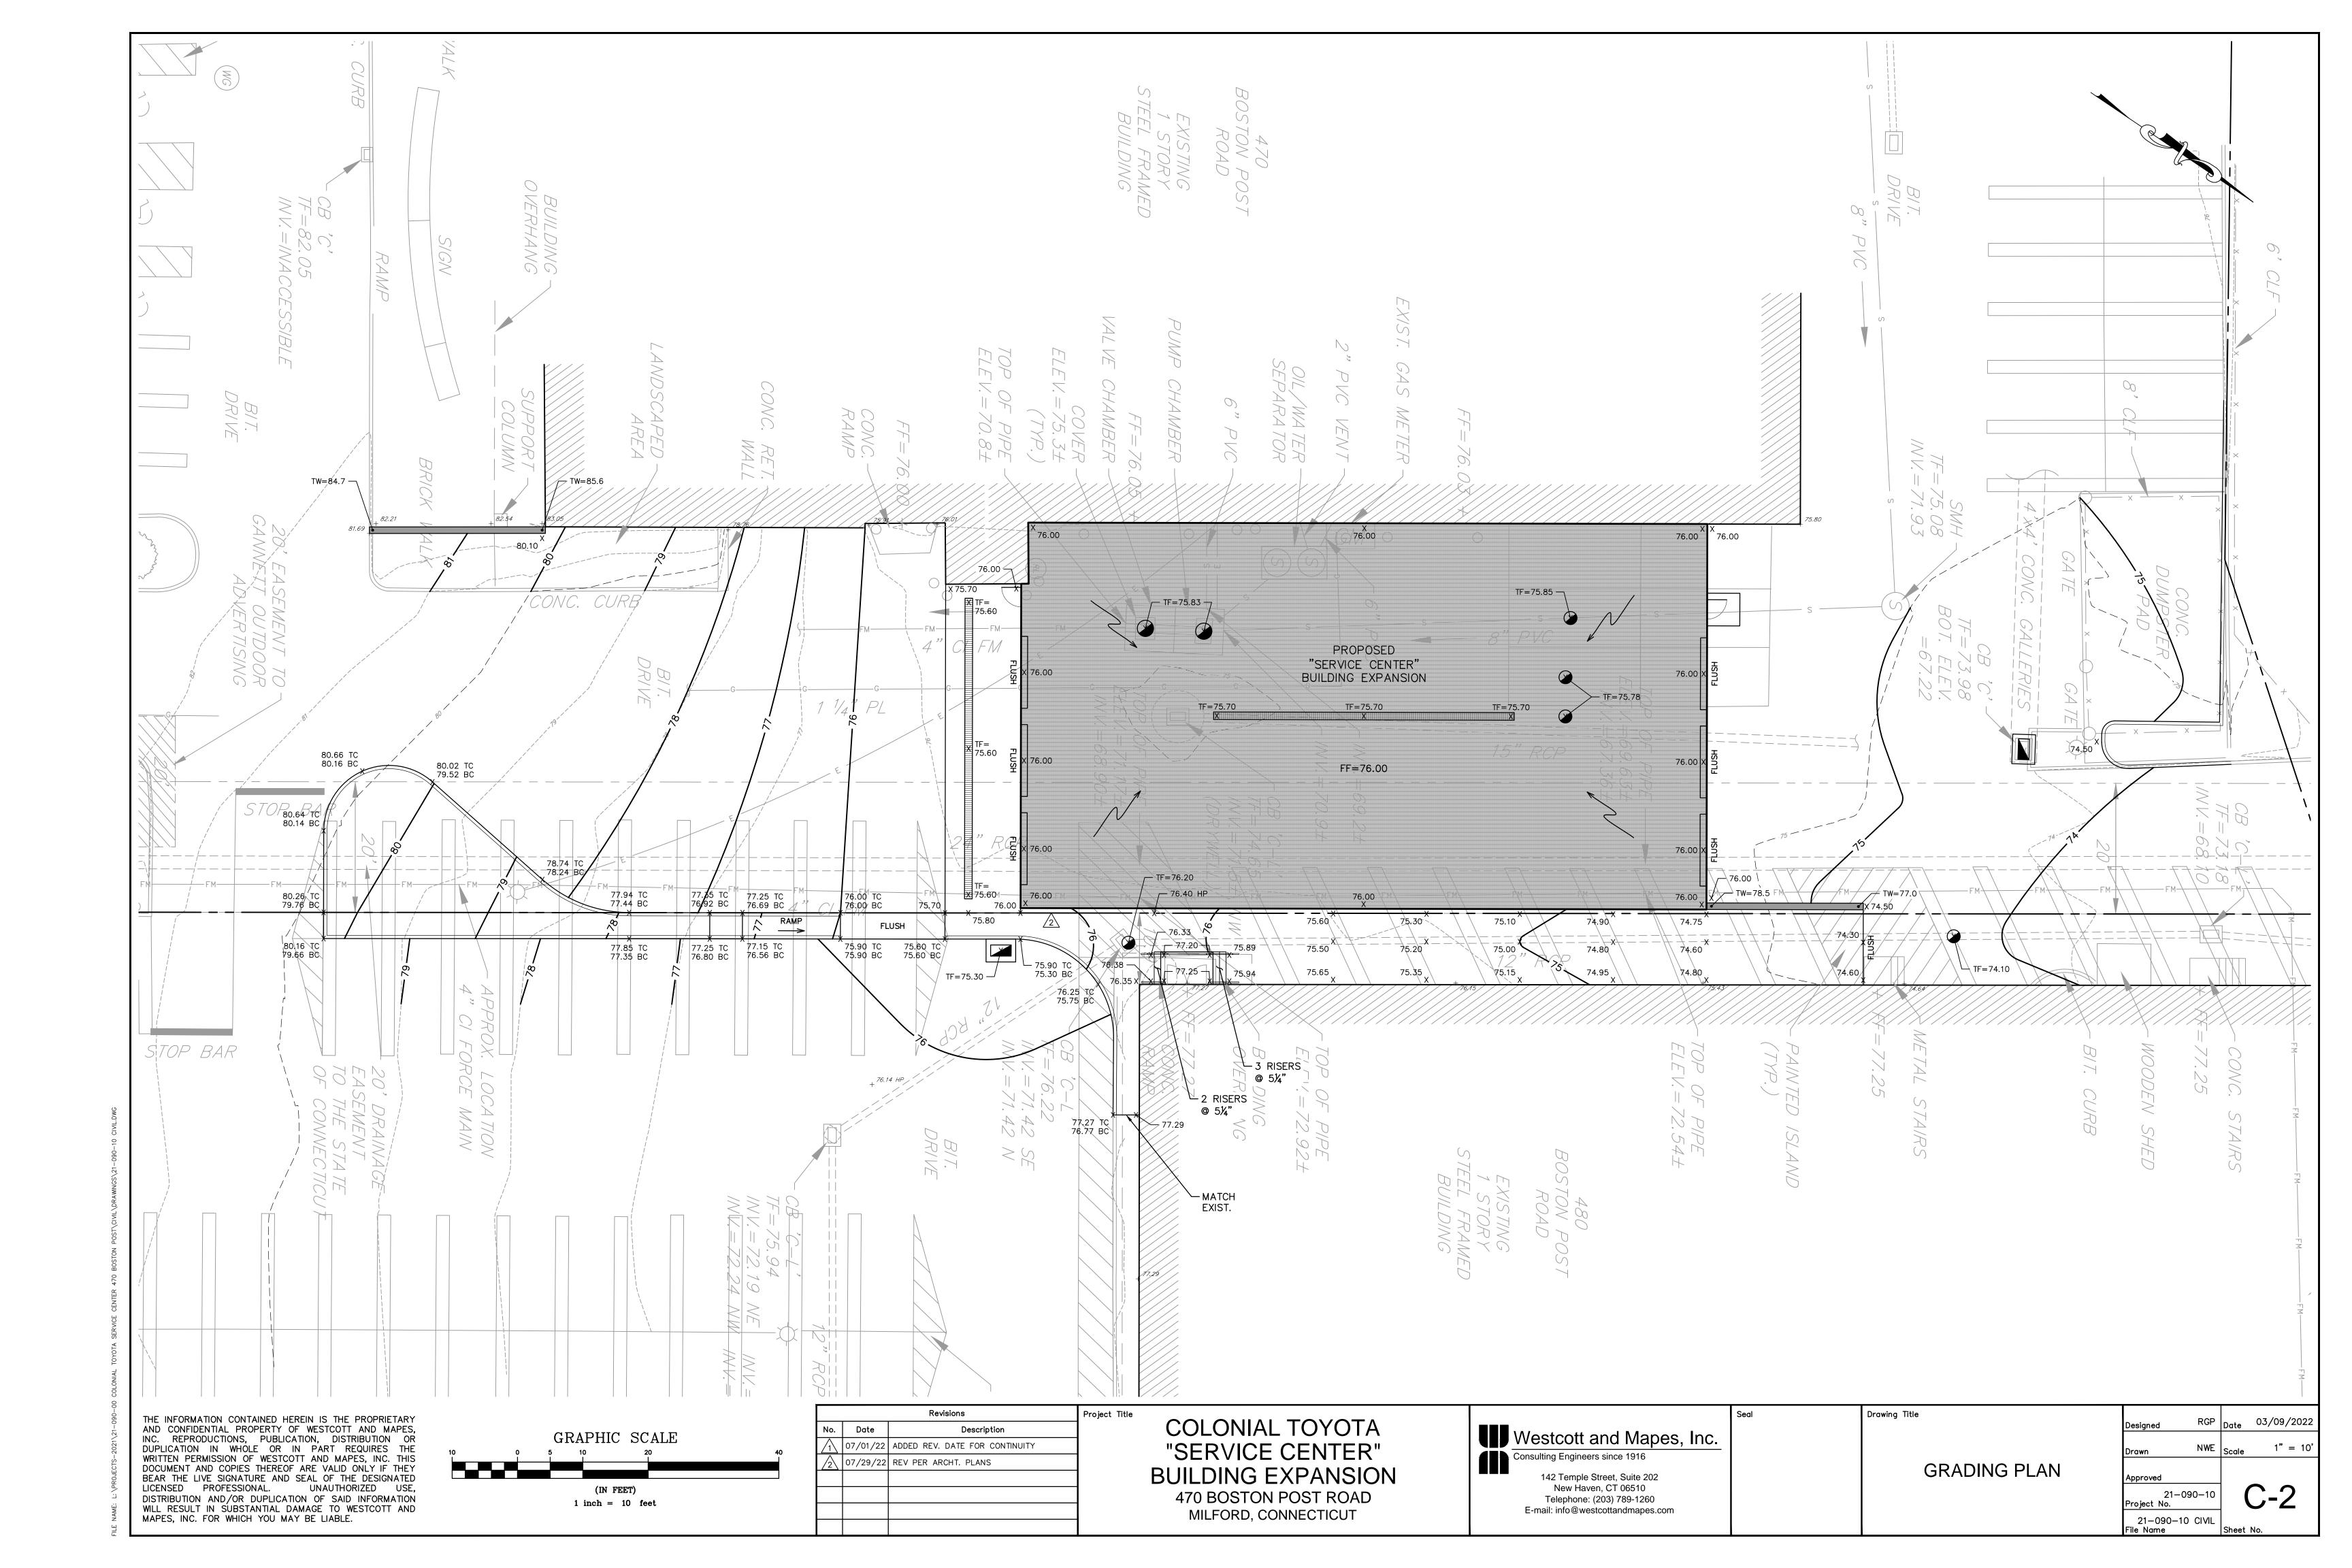
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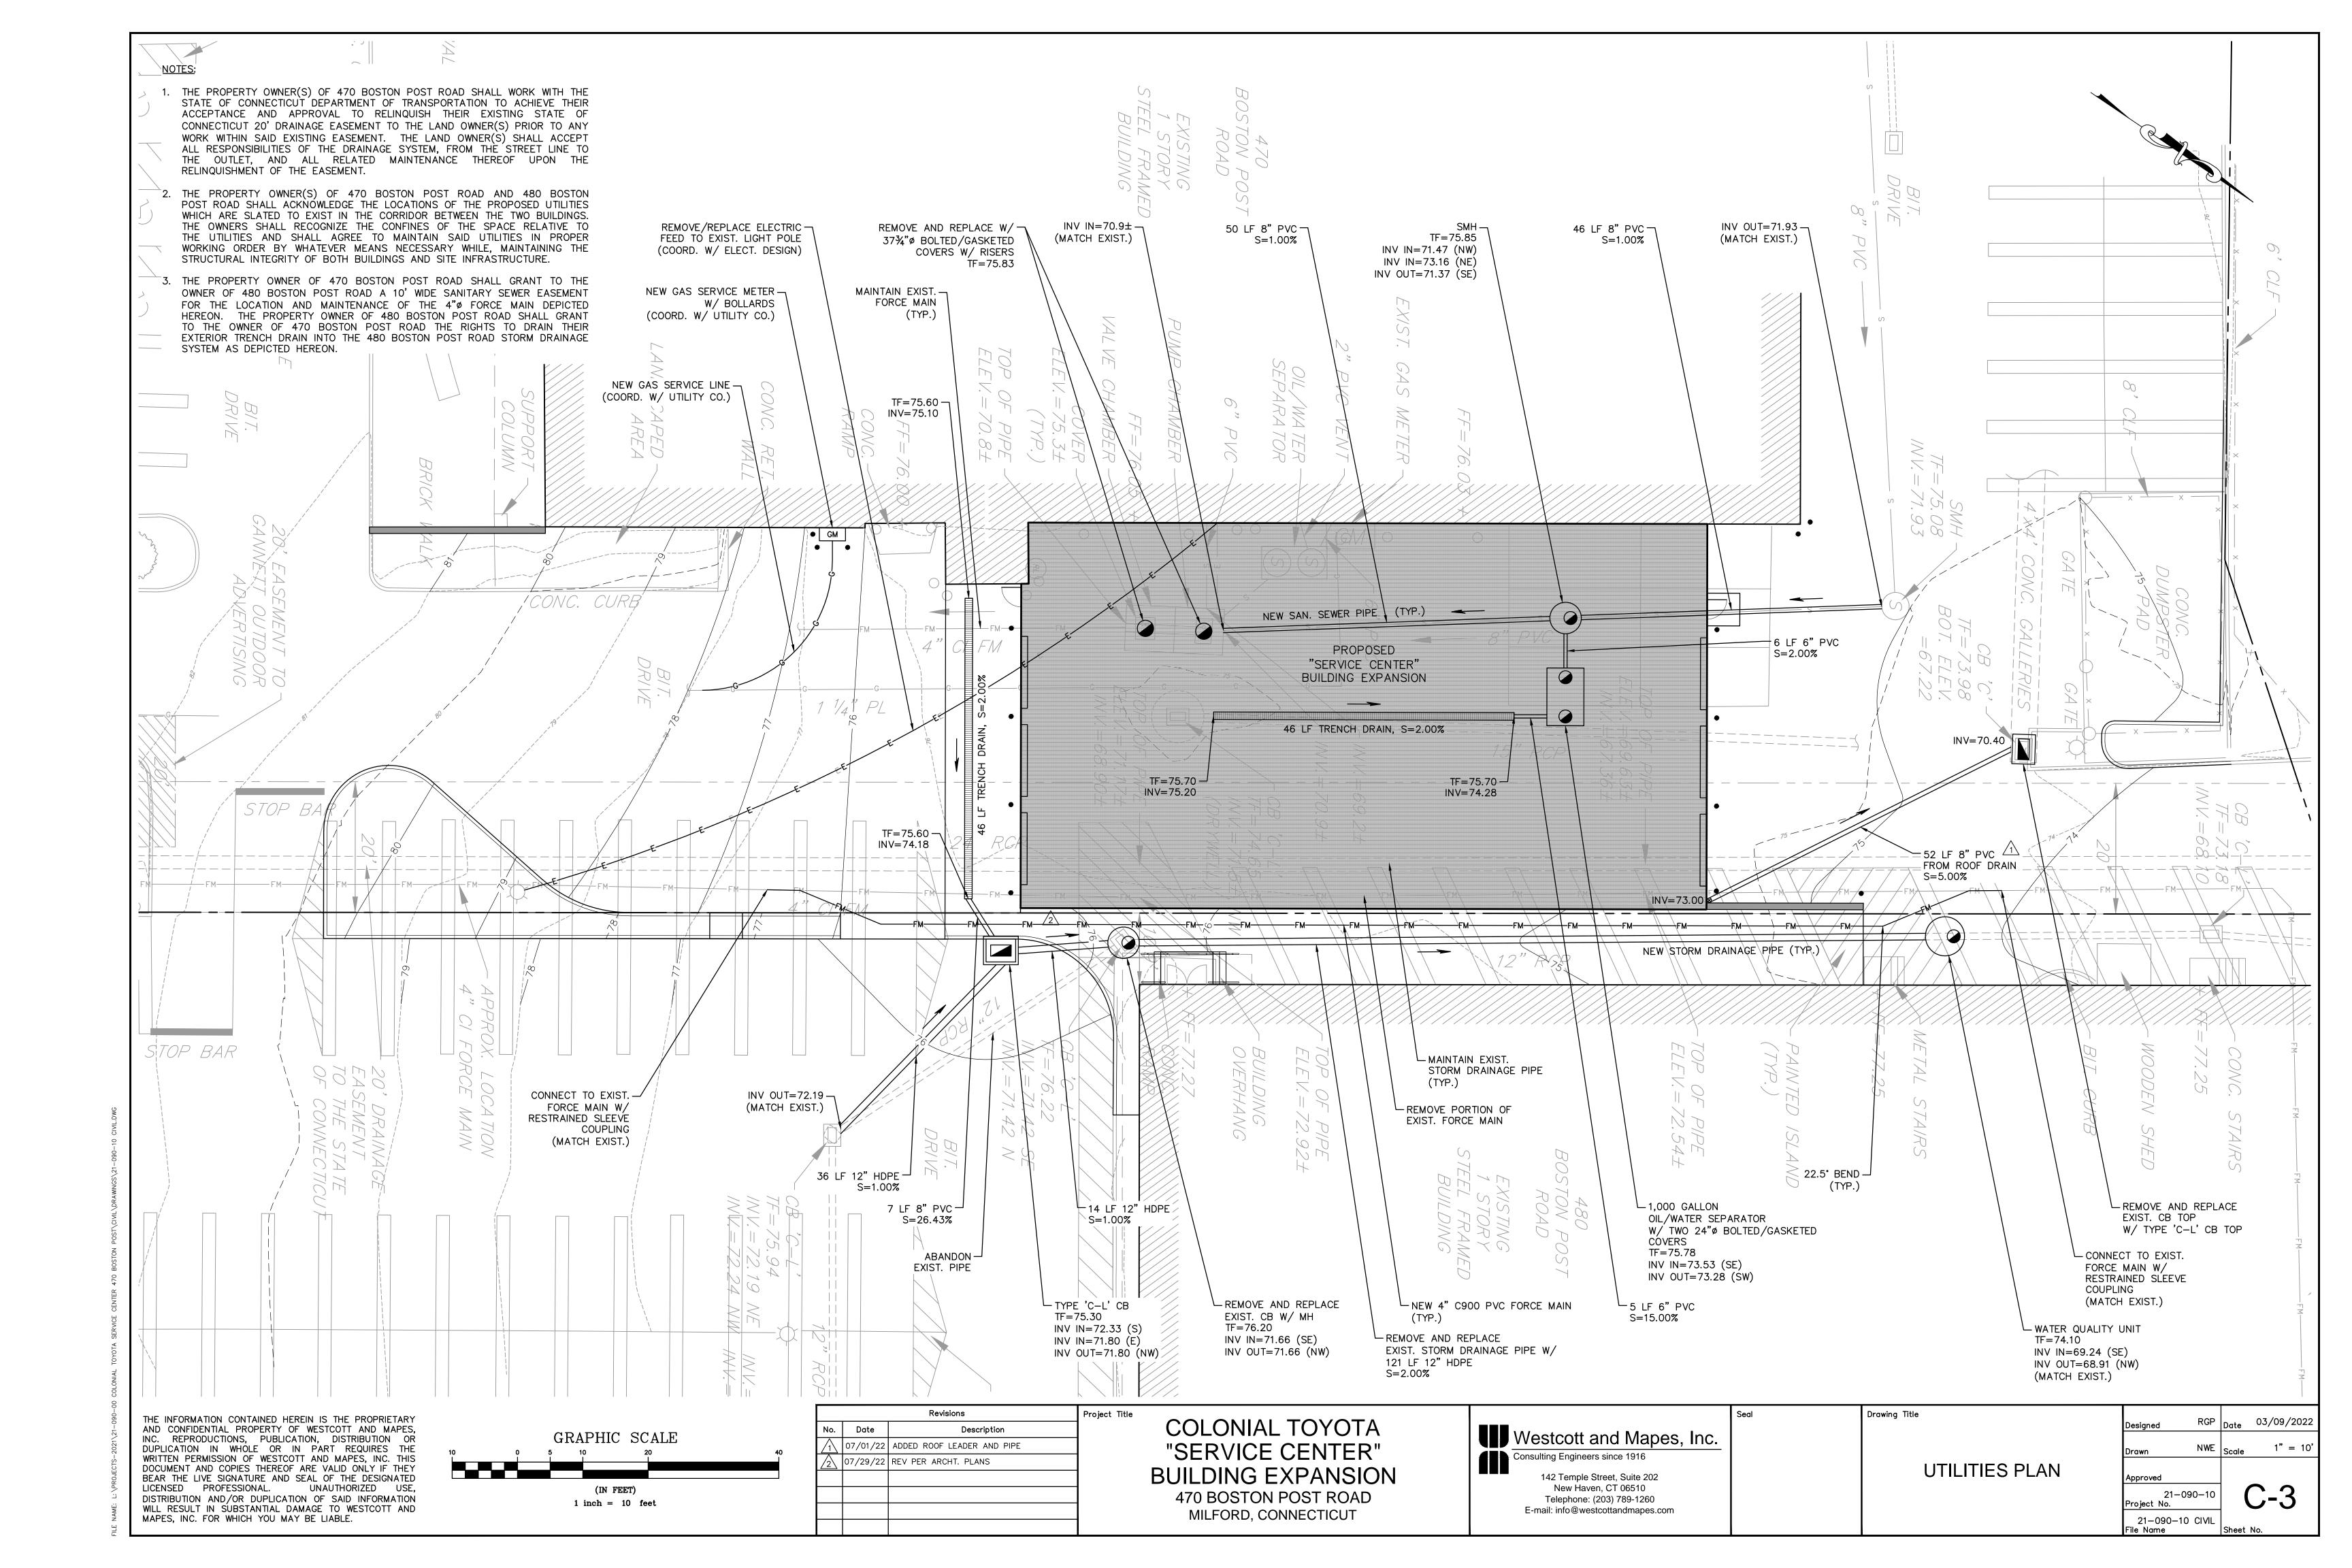
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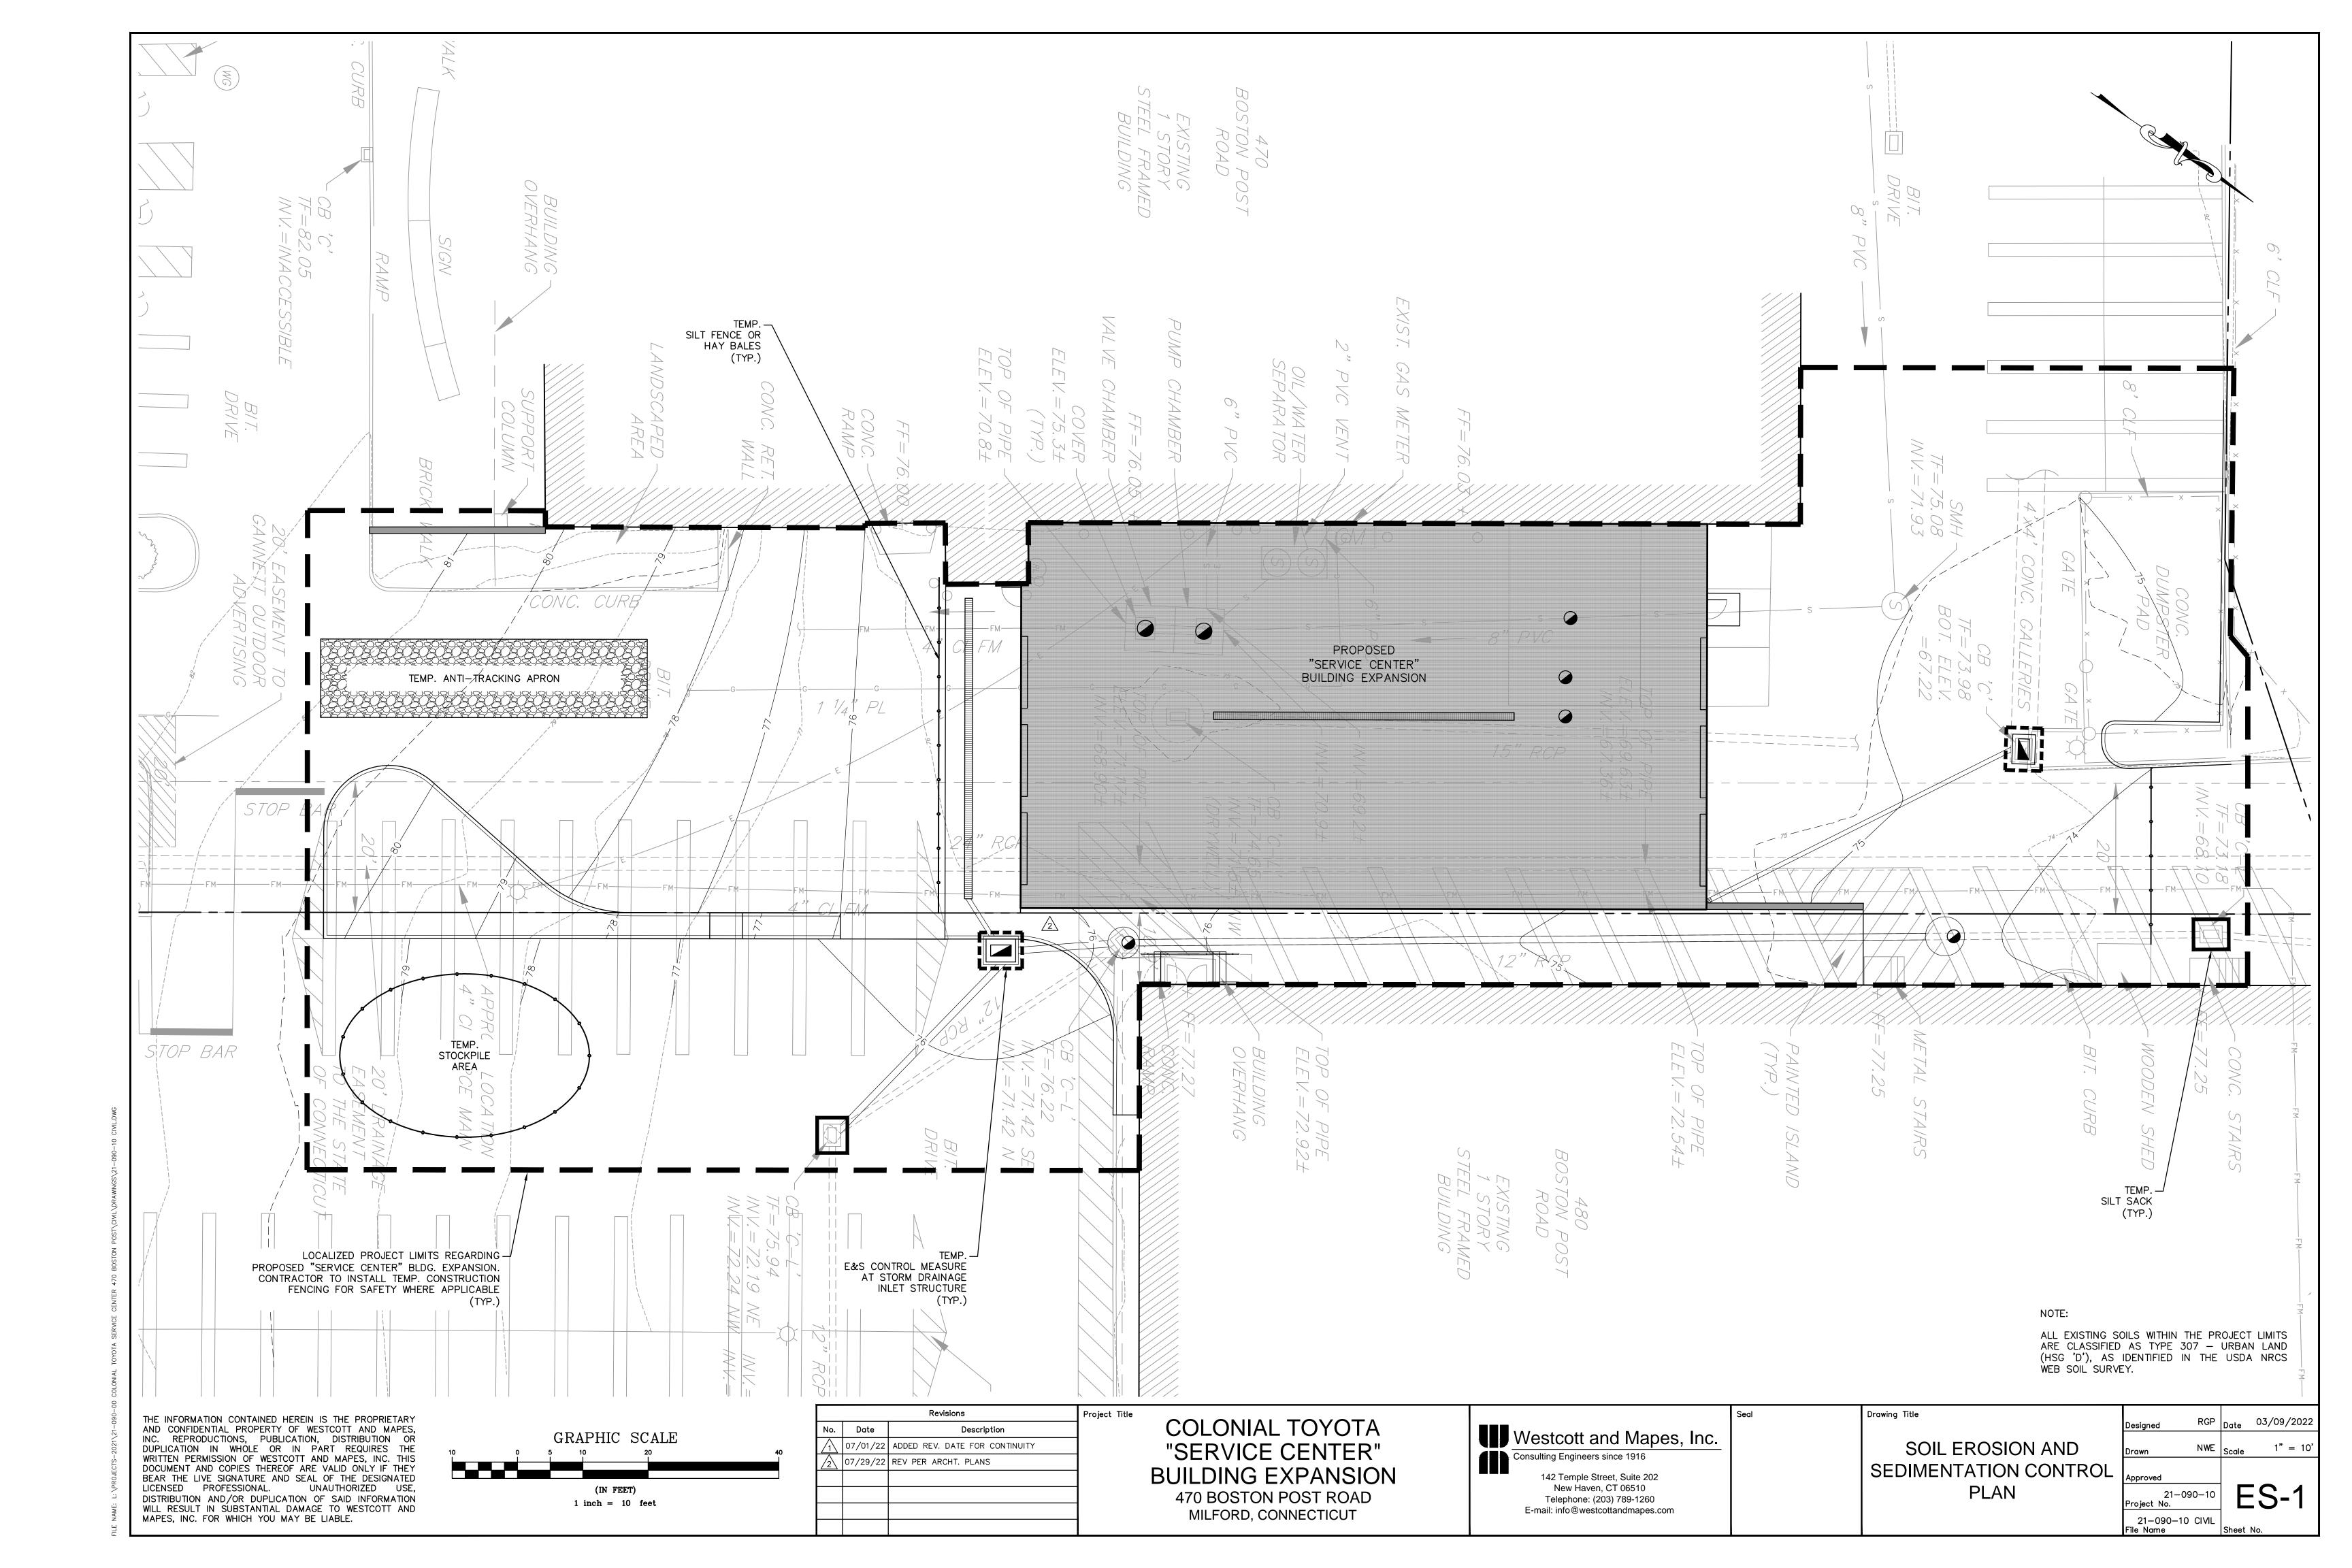
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EROSION AND SEDIMENTATION CONTROL NARRATIVE

- 1. THE SUBJECT PROPERTY, KNOWN AS "COLONIAL TOYOTA", IS LOCATED AT 470 BOSTON POST ROAD IN MILFORD, CONNECTICUT.
- 2. THERE ARE NO WETLANDS OR WATERCOURSES LOCATED ON OR IN CLOSE PROXIMITY TO THE SUBJECT SITE.
- 3. CONSTRUCTION IS SCHEDULED TO COMMENCE AFTER APPROVALS. IT IS ANTICIPATED THAT CONSTRUCTION WILL BE COMPLETED IN LESS THAN ONE (1) YEAR FROM THE DATE OF COMMENCEMENT.

CONSTRUCTION SEQUENCE

THE CONTRACTOR SHALL DO THE FOLLOWING:

- 1. SEEK PERMITS, POST BONDS AND NOTIFY/COORDINATE WITH THE CITY OF MILFORD AND THE OWNER; HE SHALL PROVIDE HIS INTENDED DETAILED CONSTRUCTION SCHEDULE AT LEAST ONE MONTH PRIOR TO HIS INTENDED START DATE.
- 2. SECURE THE SITE WITH TEMPORARY CONSTRUCTION FENCING. ESTABLISH THE CONSTRUCTION OFFICE/TRAILER, IF APPLICABLE, AND MOBILIZE EQUIPMENT.
- 3. INSTALL EROSION AND SEDIMENTATION CONTROL MEASURES AT THE LOCATIONS INDICATED ON THE SOIL EROSION AND SEDIMENTATION CONTROL PLAN AND IN ACCORDANCE WITH THE STATE OF CONNECTICUT GUIDELINES FOR SOIL EROSION AND SEDIMENT CONTROL MANUAL, LATEST EDITION.
- 4. RAZE/DEMOLISH EXISTING STRUCTURES AND FEATURES IN THE DESIGNATED AREAS AS REQUIRED FOR CONSTRUCTION OF THE NEW WORK. PROPERLY DISPOSE OF THE DEMOLISHED MATERIALS.
- 5. COORDINATE WITH THE UTILITY COMPANIES AND PERFORM UTILITY WORK AS APPLICABLE.
- 4. MAINTAIN EROSION AND SEDIMENTATION CONTROL MEASURES THROUGHOUT THE PROJECT.
- 5. EXCAVATE FOR UTILITIES, STORM DRAINAGE, STRUCTURES, AND/OR FOUNDATIONS AS APPROPRIATE.
- 6. INSTALL UTILITIES SUCH AS STORM DRAINAGE, SANITARY SEWERS, AND ELECTRICAL CONDUITS. BACKFILL AND COMPACT TRENCHES.
- 7. CONSTRUCT CONCRETE FOUNDATIONS AND RELATED STRUCTURES. BACKFILL AND COMPACT WITH APPROPRIATE SOILS/STRUCTURAL FILL MATERIALS.
- 8. CONSTRUCT THE BUILDING AND ASSOCIATED BUILDING FEATURES.
- 9. PERFORM EARTHWORK AND SITE GRADING.
- 10. PLACE, GRADE, AND COMPACT GRANULAR FILL AND PROCESSED AGGREGATE MATERIAL FOR WALKWAYS, DRIVEWAYS, AND OTHER HARDSCAPE FEATURES.
- 11. PREPARE FORMS, PLACE REINFORCING, AND CONSTRUCT ALL CONCRETE HARDSCAPE FEATURES.
- 12. INSTALL CURBING AND CONSTRUCT/POUR BITUMINOUS CONCRETE PAVEMENT.
- 13. APPLY PAINTED PAVEMENT MARKINGS AND TRAFFIC/SITE SIGNAGE, AS APPLICABLE.
- 14. PLACE TOPSOIL AND SEED WHERE APPLICABLE.
- 15. INSTALL PLANTING AND GROUND COVER WHERE APPLICABLE.
- 16. REMOVE E&S MEASURES ONCE VEGETATION IS FULLY ESTABLISHED.

SOIL EROSION AND SEDIMENT CONTROL GUIDELINES

- 1. THE SOIL EROSION AND SEDIMENTATION CONTROL PLAN HAS BEEN PREPARED IN ACCORDANCE WITH THE "2002 CONNECTICUT GUIDELINES FOR SOIL EROSION AND SEDIMENT CONTROL"
- 2. THE CONTRACTOR SHALL INSTALL AND MAINTAIN E&S MEASURES IN ACCORDANCE WITH THIS PLAN SET AND THE STATE OF CONNECTICUT GUIDELINES FOR SOIL EROSION AND SEDIMENT CONTROL.
- 3. THE CONTRACTOR SHALL ACT IMMEDIATELY TO CORRECT EROSION PROBLEMS AT THE SITE IF THEY OCCUR, AND SHALL PROVIDE ADDITIONAL CONTROL MEASURES AS NECESSARY.
- 4. DISTURBANCE OF LAND SHALL BE KEPT TO A MINIMUM. DISTURBED AREAS SHALL BE RE-STABILIZED AS WORK IN THESE AREAS IS COMPLETED.
- 5. HAY BALES AND/OR SILT FENCE SHALL BE INSTALLED AROUND ALL DRAINAGE STRUCTURES AND ALONG THE TOE OF ALL SLOPES.
- 6. SOIL MATERIALS SHALL BE STOCKPILED AND SURROUNDED BY E&S CONTROL MEASURES.
- 7. THE CONTRACTOR SHALL BE RESPONSIBLE FOR SWEEPING THE ROADS IN THE EVENT OF TRACKING OF SEDIMENT FROM THE SITE.
- 8. SOIL EROSION AND SEDIMENT CONTROL MEASURES SHALL BE INSTALLED PRIOR TO ANY CONSTRUCTION ACTIVITY ON THE SITE.
- 9. CONTROL MEASURES SHALL REMAIN IN EFFECTIVE CONDITION THROUGHOUT THE CONSTRUCTION PERIOD.
- 10. DUST CONTROL MEASURES SHALL BE USED THROUGHOUT SITE DEVELOPMENT AND CONSTRUCTION OPERATIONS.
- 11. SEDIMENT REMOVED FROM CONTROL MEASURES SHALL BE DISPOSED OF IN A MANNER THAT IS CONSISTENT WITH THE INTENT OF THIS SOIL EROSION AND SEDIMENTATION CONTROL PLAN AND IN ACCORDANCE WITH STATE GUIDELINES.
- 12. SILT FENCE AND STAKED HAY BALES SHALL BE INSTALLED AT THE LOCATIONS SHOWN ON THE PLAN AND IN ADDITIONAL LOCATIONS AS MAY BE NECESSARY AND/OR DIRECTED BY THE ENGINEER OR ENFORCEMENT OFFICER.
- 13. WHEREVER FEASIBLE, NATURAL VEGETATION SHOULD BE RETAINED AND PROTECTED.
- 14. THE OWNER'S SITE MANAGER IS ASSIGNED THE RESPONSIBILITY OF IMPLEMENTING THIS SOIL EROSION AND SEDIMENT CONTROL PLAN. THIS RESPONSIBILITY INCLUDES ENFORCING THE INSTALLATION AND MAINTENANCE OF CONTROL MEASURES, INFORMING ALL PARTIES ENGAGED ON THE CONSTRUCTION SITE OF THE REQUIREMENTS AND OBJECTIVES OF THE PLAN, AND MONITORING ALL SOIL EROSION AND SEDIMENT CONTROL MEASURES THROUGHOUT THE DURATION OF THE PROJECT.

DEWATERING

IN THE EVENT THAT WATER IS ENCOUNTERED, THE CONTRACTOR IS RESPONSIBLE FOR PROPERLY DISPOSING AND ADEQUATELY DEWATERING ALL OF HIS TRENCHING AND EXCAVATION ACTIVITIES, AS APPLICABLE. SAID RESPONSIBILITIES SHALL INCLUDE BUT NOT BE LIMITED TO USING AND MAINTAINING ENOUGH DEWATERING PUMPS FOR THE AREA OF OPEN EXCAVATIONS TO PRODUCE DRY CONDITIONS. THE USE OF 3/4" CRUSHED STONE MAY BE USED AT THE BOTTOM OF MOIST UTILITY TRENCHES. NO PIPES OR OTHER UTILITIES MAY BE INSTALLED IN WATER. THE DISCHARGE OF THE DEWATERING PUMPS MUST BE FILTERED THROUGH A FILTRATION/SEDIMENT TRAPPING DEVICE SUCH AS A 'DIRTBAG', A PERFORATED 55 GALLON DRUM FILLED WITH CRUSHED STONE, SLOW OVERFLOW DUMPSTER, FRAC TANK, SEDIMENT TRAP OR THE LIKE. SAID DEVICES AND DEWATERING OPERATIONS MUST BE OBSERVED AND APPROVED BY THE ENFORCEMENT OFFICER. IF DEEMED INSUFFICIENT, ADDITIONAL MEASURES SHALL BE IMPLEMENTED.

50' MIN. SAND OR GRAVEL CONDITION EXTEND AS NECESSARY TO PREVENT TRACKING OF SOIL ONTO STREET PAVEMENT 10' MIN. 12' MIN. WIDTH PLAN VIEW – 50' – 100' MIN. – (SEE APPLICATION NOTE 'C') ORIGINAL GROUND -EDGE OF EXIST. SURFACE PAVEMENT STRIP TOPSOIL GEOTEXTILE -└─MIN. 8"AGGREGATE FROM ENTIRE AREA OVER LENGTH AND WIDTH OF ENTRANCE OF CONSTRUCTION ENTRANCE

SECTION VIEW

CONSTRUCTION ENTRANCE NOTES:

DEFINITION:

- AN ENTRANCE TO THE SITE SPECIFICALLY DESIGNED TO REDUCE THE AMOUNT OF SEDIMENT TRACKED OFF-SITE BY VEHICLES.
- A. LOCATED WHERE CONSTRUCTION VEHICLES ENTER AND LEAVE WORK SITE ONTO PUBLIC R.O.W.
- B. REDUCES BUT MAY NOT ELIMINATE NEED FOR STREET SWEEPING.
- C. FOR SANDY OR GRAVELY SOIL ON SITE, MINIMUM LENGTH IS 50'. FOR SILTY OR CLAY SOILS ON SITE, MINIMUM LENGTH IS 100'.
- D. PLAN TO MAKE STONE AVAILABLE FOR MAINTENANCE OF ENTRANCE.

INSTALLATION:


- 1. CLEAR ENTRANCE OF ALL VEGETATION AND EXTRANEOUS MATERIALS AND STRIP EXISTING TOPSOIL FROM CONSTRUCTION ENTRANCE.
- 2. AT POORLY DRAINED LOCATION INSTALL SUBSURFACE DRAINAGE, PROVIDE FOR SURFACE WATER CONVEYANCE UNDER ENTRANCE WITH CULVERTS AS NEFDED.
- 3. PLACE FILTER FABRIC UNDERLINER OVER FULL WIDTH AND LENGTH OF ENTRANCE AND COVER WITH CT DOT #3 (2") STONE TO A DEPTH OF NO LESS THAN 8".
- 4. AS NEEDED INSTALL WASH RACKS AND SEDIMENTATION FACILITIES FOR WASHING. WHEN MAJORITY OF MUD IS NOT REMOVED FROM VEHICLES TRAVELING OVER STONE, SEDIMENT SHOULD BE INTERCEPTED AND TRAPPED SO IT CAN BE REMOVED AND STABILIZED.

MAINTENANCE:

- 1. AS REQUIRED, APPLY ADDITIONAL STONE OR WASH AND REWORK EXISTING STONE.
- 2. REMOVE ANY SEDIMENT APPEARING ON ROADWAYS OR STORM DRAINS

PLACEMENT & CONSTRUCTION OF A STABILIZED CONSTRUCTION ENTRANCE

N.T.S.

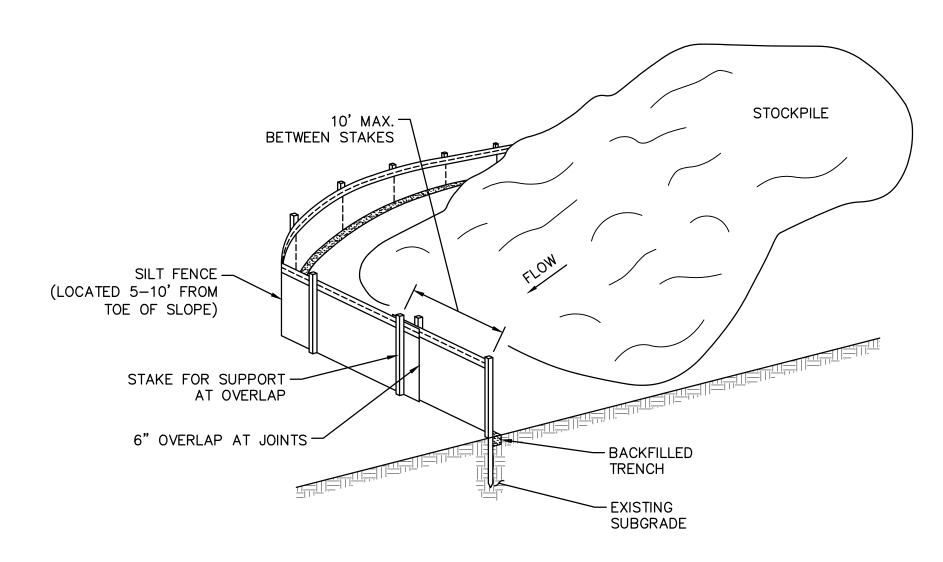


PLACEMENT & CONSTRUCTION OF SILT FENCE N.T.S.

SILT FENCE INSTALLATION:

- LOCATE AS NECESSARY FOR APPLICATION (SEE PLANS).
- 2. EXCAVATE TRENCH A MINIMUM 6" DEEP BY 6" WIDE ON UPSLOPE SIDE OF FENCE. FOR SLOPES, EXTEND TRENCH UPSLOPE AT BOTH ENDS OF THE FENCE TO PREVENT WATER FROM RUNNING AROUND. ENCIRCLE CATCH BASINS IN DEPRESSIONS, CUTTING FABRIC ON THE BOTTOM CORNERS 4"± TO ALLOW FABRIC TO LAY FLAT AROUND CORNER.
- 3. DRIVE HARDWOOD STAKES (1½" X 1½" X 42" MIN.) ON DOWNSLOPE SIDE OF TRENCH AT A MAXIMUM SPACING OF 10', OR CLOSER WHEN CONCENTRATED FLOWS ARE ANTICIPATED.
- 4. STAPLE OR SECURE FENCE TO STAKES PER MANUFACTURER'S INSTRUCTIONS SUCH THAT AT LEAST 8" OF FABRIC LAYS WITHIN TRENCH. IN THE ABSENCE OF MANUFACTURER'S INSTRUCTION'S, SPACE WIRE STAPLES 4" APART ALTERING PARALLEL AND PERPENDICULAR TO THE AXIS OF THE STAPLE.


5. PLACE FABRIC JOINTS AT STAKES WITH A 6"

- OVERLAP OF FABRIC.
- 6. BACKFILL AND COMPACT TRENCH.

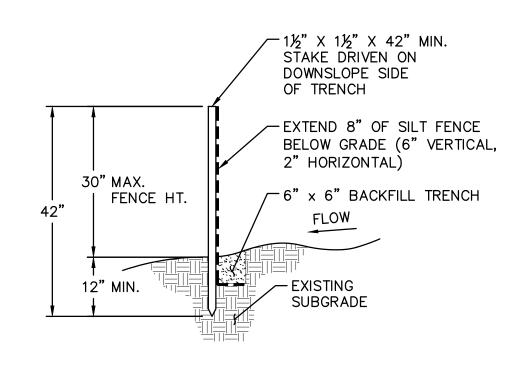


SILT FENCE N.T.S.

HAY BALES INSTALLATION: 1. EXCAVATE TRENCH, ON CONTOUR, TO WIDTH OF BALE AND DEPTH OF 4". 2. LOCATE BALES AS SHOWN, TIGHTLY ABUTTING ONE ANOTHER. 3. EXTEND ENDS OF TRENCH UPSLOPE IN EACH DIRECTION SO THAT THE BOTTOM END OF BALES WILL BE HIGHER THAN THE TOP OF THE LOWEST BALES TO FORCE WATER OVER THE TOP OF THE STRUCTURE. 4. DRIVE AT LEAST 2 HARDWOOD STAKES (1" X 1" X 36") TO ANCHOR EACH BALE TO THE GROUND, TO MINIMUM DEPTH OF 6". 5. BACKFILL ON UPSLOPE SIDE OF BALE AND COMPACT TRENCH WITH A MINIMUM OF 4" OF

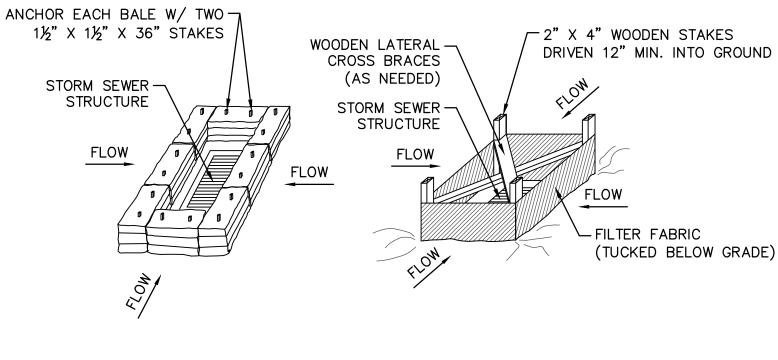


EROSION AND SEDIMENTATION CONTROL AT STORM DRAINAGE INLET STRUCTURE

N.T.S.

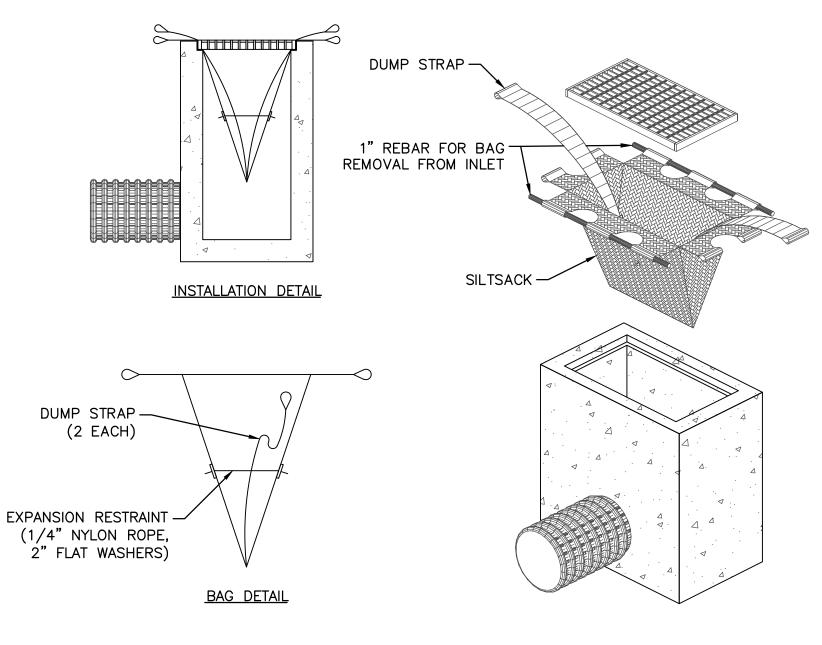

SILTSACK DETAIL N.T.S.

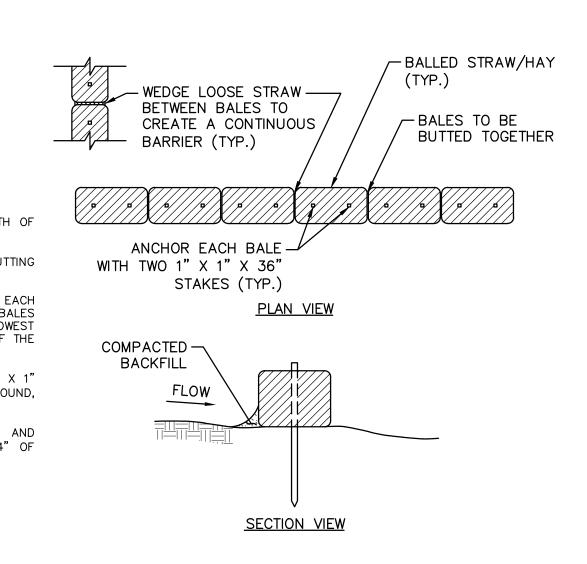

HAY BALES

		Revisions	Proje
No.	Date	Description	
1	07/01/22	ADDED REV. DATE FOR CONTINUITY	
2	07/29/22	ADDED REV. DATE FOR CONTINUITY	

COLONIAL TOYOTA
"SERVICE CENTER"
BUILDING EXPANSION
470 BOSTON POST ROAD

MILFORD, CONNECTICUT



Telephone: (203) 789-1260

E-mail: info@westcottandmapes.com

SOIL EROSION AND SEDIMENTATION CONTROL NARRATIVE AND DETAILS

Drawing Title

Designed RGP Date 03/09/2022


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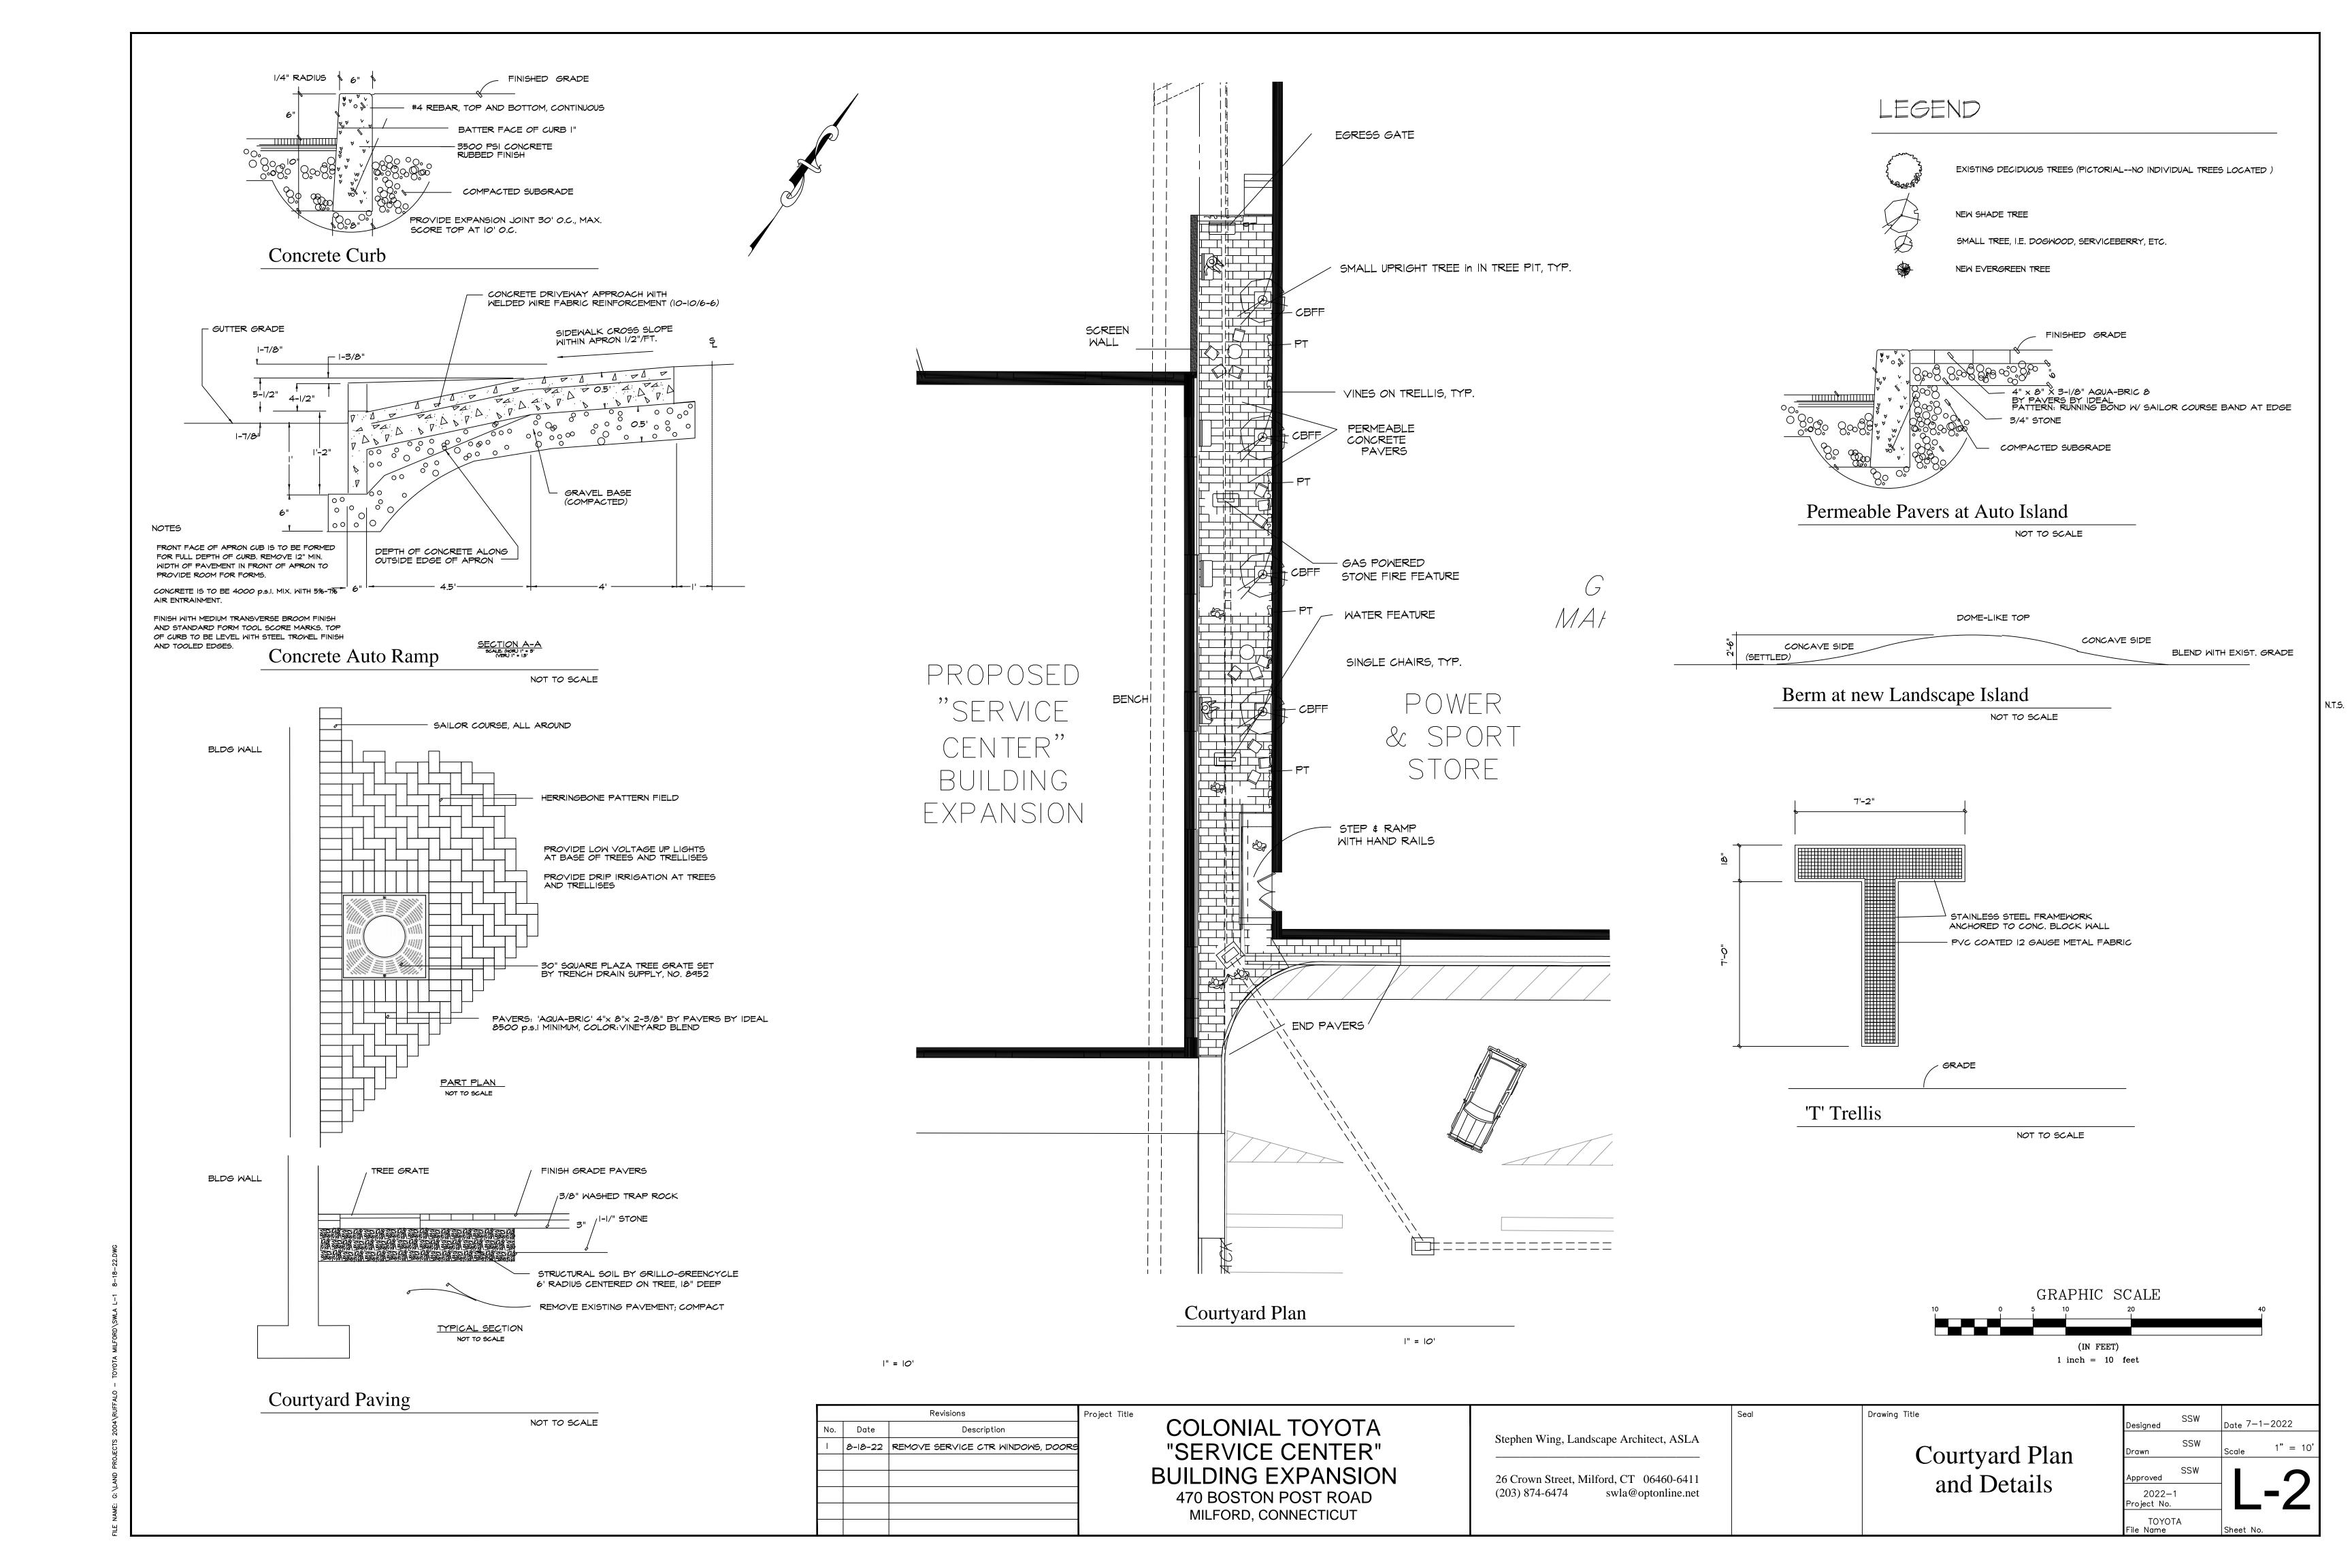
Approved

21-090-10 Project No.


21-090-10 CIVIL Sheet No.

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PLAN VIEW

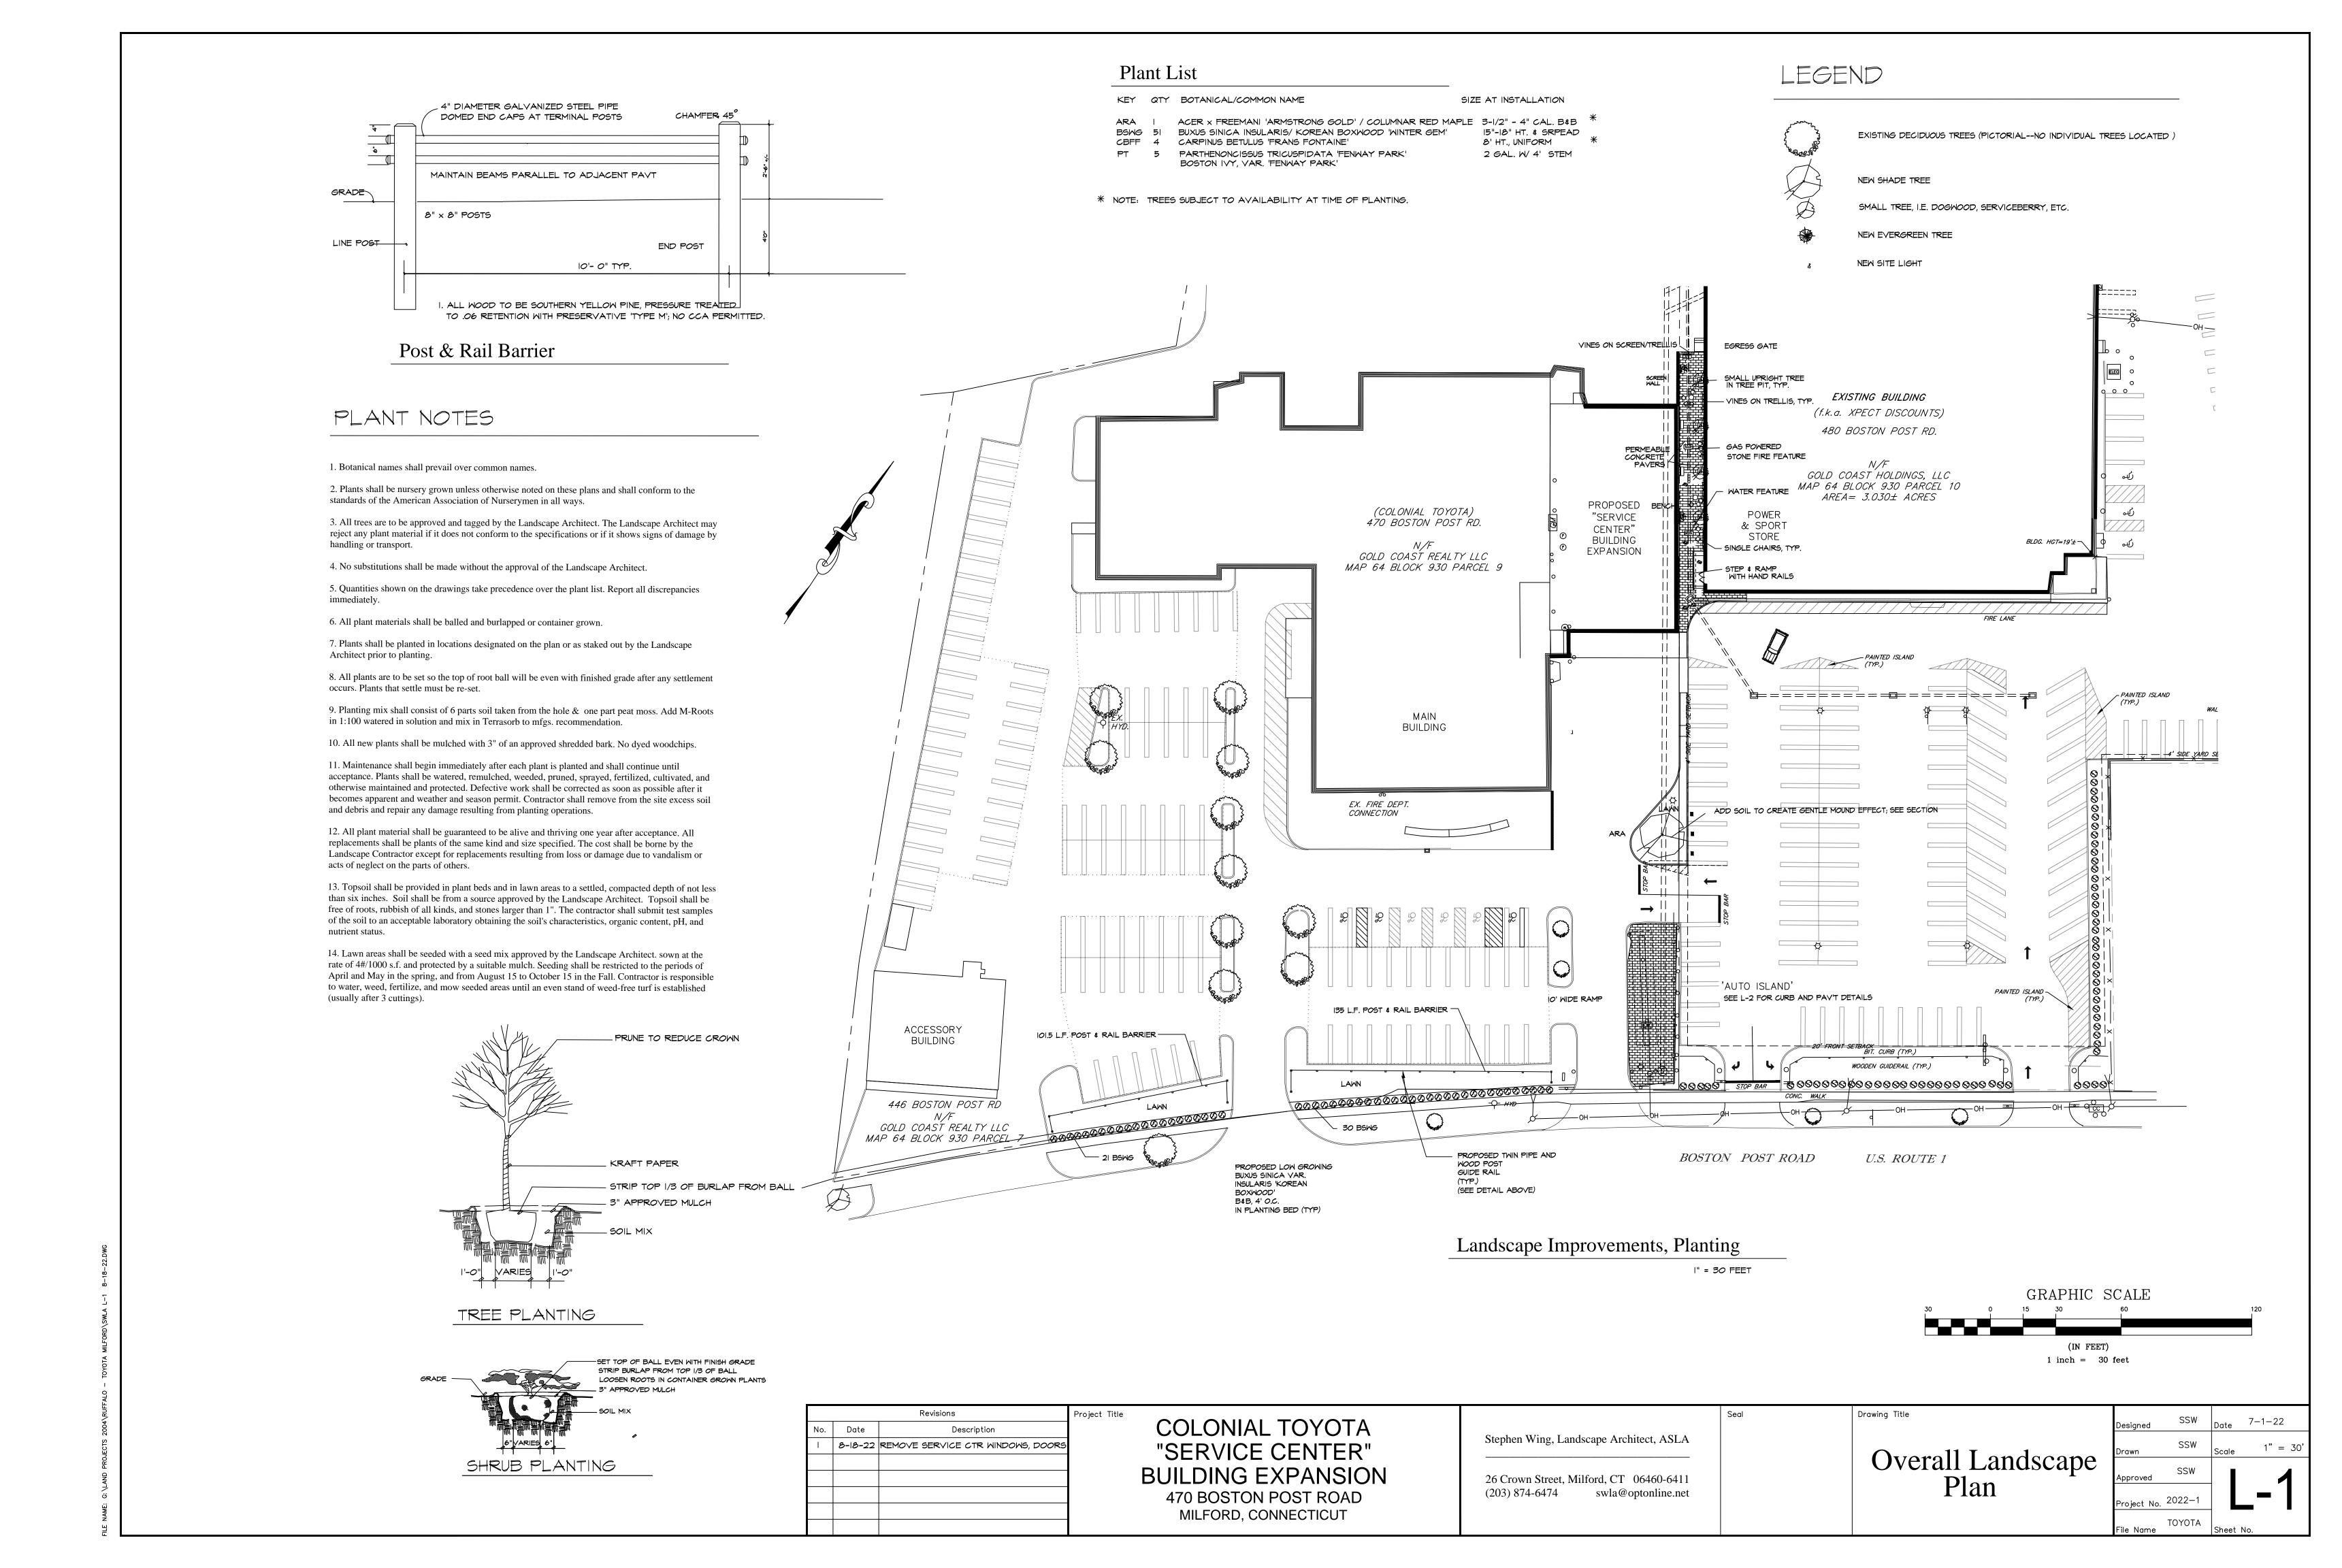


NOTES:

- 1. MANHOLE FRAME AND COVER SHALL BE CAMPBELL FOUNDRY PATTERN 1032, OR APPROVED EQUAL.
- 2. FOR STORM DRAIN MANHOLES, THE WORD "STORM" SHALL REPLACE THE WORD "SEWER" ON THE MANHOLE COVER.

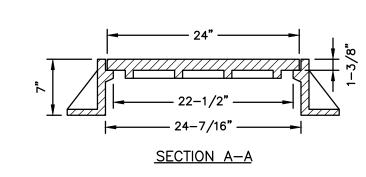STANDARD SANITARY SEWER AND STORM MANHOLE FRAME AND COVER

N.T.S.

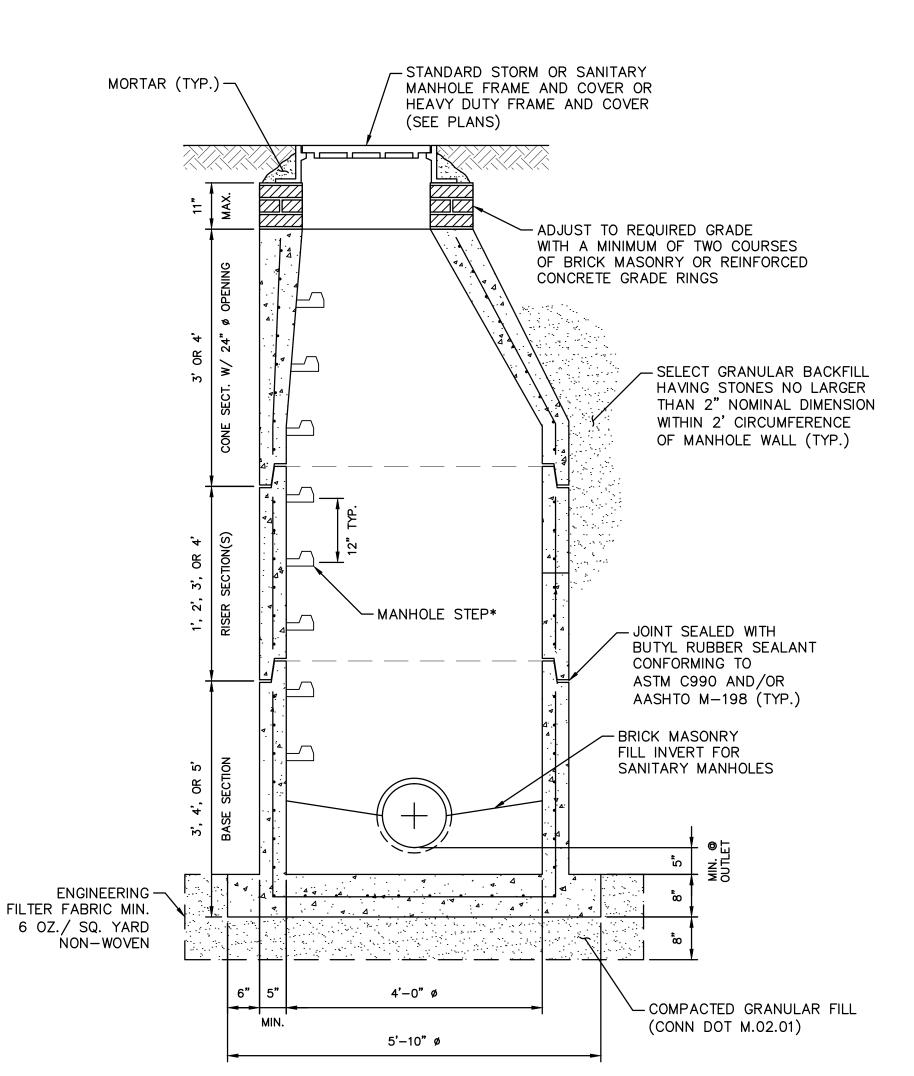

- 1. CONCRETE 5000 PSI 28 DAYS.
- 2. MANHOLES SHALL BE MANUFACTURED IN ACCORDANCE WITH ASTM C478.
- 3. MANHOLE STEPS SHALL BE COPOLYMER POLYPROPYLENE COATED STEEL CORE MANUFACTURED BY MA INDUSTRIES, INC., PEACHTREE CITY, GA.


SECTION VIEW

- 4. INSTALL MANHOLE BASE ON 8" THICK BASE OF 34" CRUSHED STONE.
- 5. REINFORCING STEEL CONFORMS TO ASTM A185 WITH MINIMUM AREA AS 48" Ø - 0.12 SQ. IN./VERTICAL FOOT.
- 6. PRECAST MANHOLES SHALL BE AS MANUFACTURED BY CONNECTICUT PRECAST CORPORATION, MONROE, CONNECTICUT, OR APPROVED EQUAL.

MANHOLE N.T.S.

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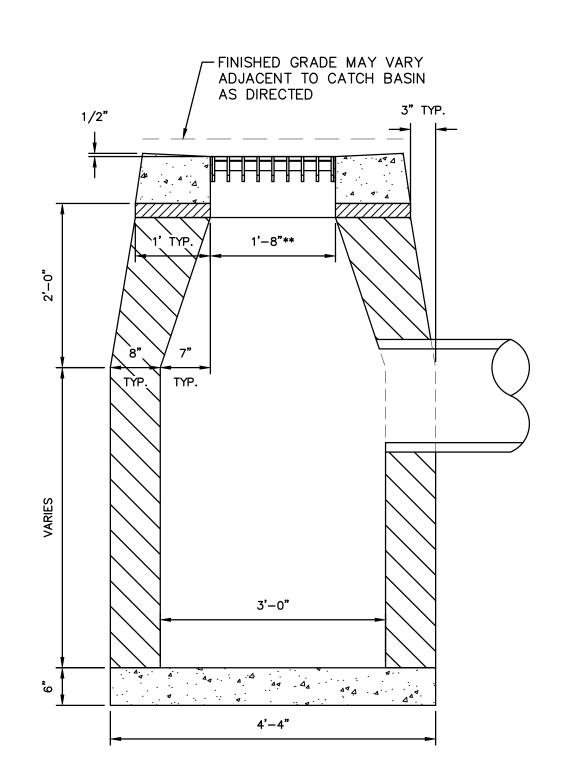



GENERAL FOUNDRIES HEAVY DUTY MANHOLE FRAME AND COVER DIMENSIONS

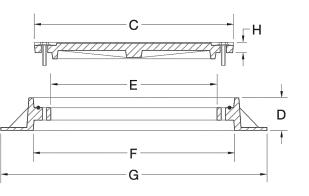	COVER DIAMETER	FRAME HEIGHT	CLEAR OPENING	FLANGE I.D.	FLANGE O.D.	COVER THICKNESS
PRODUCT NO.	С	D	Е	F	G	Н
12446	24"	4"	22-3/8"	24-1/4"	32"	1-3/8"
13646	37-3/4"	4"	33-1/2"	38"	48"	1-1/2"

- 1. HEAVY DUTY MANHOLE FRAME AND COVER SHALL BE AS MANUFACTURED BY GENERAL FOUNDRIES, OR APPROVED EQUAL.
- 2. REFER TO UTILITY PLAN FOR LOCATIONS AND TYPES OF HEAVY DUTY MANHOLE FRAMES AND COVERS.

HEAVY DUTY MANHOLE FRAME AND COVER



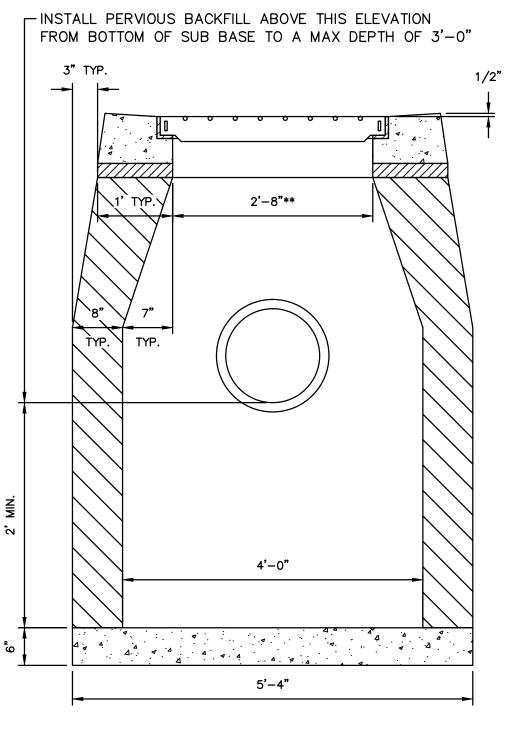

- 1. ALL FACES OF STRUCTURES IN CONTACT WITH CONCRETE PAVEMENT SHALL BE COVERED WITH A LAYER OF TAR PAPER OR APPROVED EQUAL. THE COST FOR THE PAPER SHALL BE INCLUDED IN THE BID PRICE FOR THE TYPE OF CATCH BASIN INSTALLED.
- 2. IF MASONRY UNITS ARE REQUIRED, THE BASIN SHALL BE CONSTRUCTED IN CONFORMANCE WITH THE OVERALL DIMENSIONS SHOWN HERE AND SECTION 5.07 OF THE STATE OF CONNECTICUT'S STANDARD SPECIFICATIONS. CORBELLING SHALL BE PERMITTED TO A MAXIMUM OF 3". NO PROJECTION SHALL EXTEND INSIDE THE LIMITS NOTED BY **.
- 3. WALL THICKNESS OF ALL CB'S OVER 10' DEEP SHALL BE INCREASED TO 12" THICK. INSIDE DIMENSION SHALL REMAIN THE SAME. 12" THICKNESS WILL START AFTER THE FIRST 10'.
- 4. TO CONVEY SUBSURFACE DRAINAGE, OPENINGS SHALL BE FORMED IN THE FOUR WALLS AT OR IMMEDIATELY ABOVE THE BOTTOM OF THE PERVIOUS BACKFILL.
- 5. MINIMUM CONCRETE COMPRESSIVE STRENGTH OF f'c = 4,000 PSI (27,580 kPa) SHALL BE OBTAINED PRIOR TO SHIPPING.
- 6. LATEST STATE OF CONNECTICUT'S STANDARD SPECIFICATIONS AND SUPPLEMENTALS SHALL GOVERN.
- 7. SPACER MAY BE CMU OR PRECAST WITH REQUIRED REINFORCING (RECOMMENDED BY THE MANUFACTURER) AS NEEDED TO PROVIDE PROPER GRADE SHOWN ON PLANS.
- 8. TOP OF FRAME (TF) ELEVATION SHALL BE MEASURED IN THE CENTER OF GRATE AT GUTTER LINE.

CATCH BASIN

Project Title COLONIAL TOYOTA Description 470 BOSTON POST ROAD MILFORD, CONNECTICUT



142 Temple Street, Suite 202 New Haven, CT 06510 Telephone: (203) 789-1260 E-mail: info@westcottandmapes.com

SEE PAVEMENT -TOPSOIL AND SEED OR SOD REPAIR DETAIL AS INDICATED ON THE PLANS SUITABLE GRAVEL -BACKFILL COLOR CODED METALLIC -WARNING TAPE (SEE NOTE 2) BEDDING MATERIAL (CONN DOT FORM 818, SECTION M.08.01) (SEE NOTE 1) -TRENCH WIDTH-(SEE NOTE 3)

IN GRASS AREA


IN PAVED AREA

- 1. FILL MATERIALS SHALL BE COMPACTED TO 95% DRY DENSITY UNDER PAVED AREAS, SIDEWALKS AND OTHER STRUCTURES AND TO 90% DRY DENSITY (MIN.) UNDER UNPAVED AREAS.
- 2. COLOR OF METALLIC WARNING TAPE SHALL CONFORM TO THE FOLLOWING:

BLUE - WATER GREEN - STORM AND SANITARY RED - ELECTRICAL ORANGE - COMMUNICATIONS YELLOW - GAS

- 3. TRENCH WIDTH SHALL BE D+2' WHEN D IS LESS THAN 30" AND SHALL BE D+3' WHEN D IS GREATER THAN OR EQUAL TO 30" (D = NOMINAL PIPE DIAMETER).
- 4. ALL UTILITIES SHALL HAVE A MINIMUM OF 2'-0" OF COVER OR AS DIRECTED BY THE ENGINEER, UTILITY AGENCY, OR UNLESS OTHERWISE INDICATED.

TYPICAL UTILITY AND STORM SEWER TRENCH N.T.S.

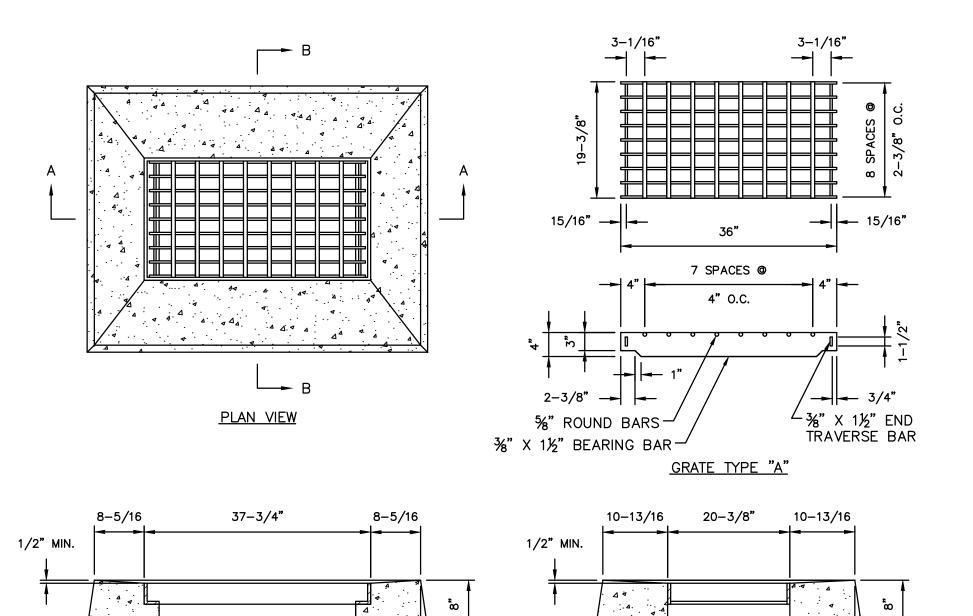

32-3/4"

SECTION A-A

12"

1. CATCH BASIN TOPS SHALL BE APPROVED PRECAST UNITS, FACTORY MANUFACTURED.

12"

20-3/8"

SECTION B-B

1-3/16"

12"

Drawing Title

2. FRAMES AND GRATES SHALL BE GALVANIZED STEEL PER CONN DOT SPECIFICATIONS.

TYPE "C-L" CATCH BASIN TOP


DETAILS


RGP $|_{Date}$ 03/09/202 NWE | Scale AS NOTED CONSTRUCTION 21-090-10 21-090-10 CIVIL


--- 1−3/16"

Revisions No. Date \ 07/01/22 ADDED REV. DATE FOR CONTINUITY 07/29/22 ADDED REV. DATE FOR CONTINUITY


"SERVICE CENTER" **BUILDING EXPANSION**

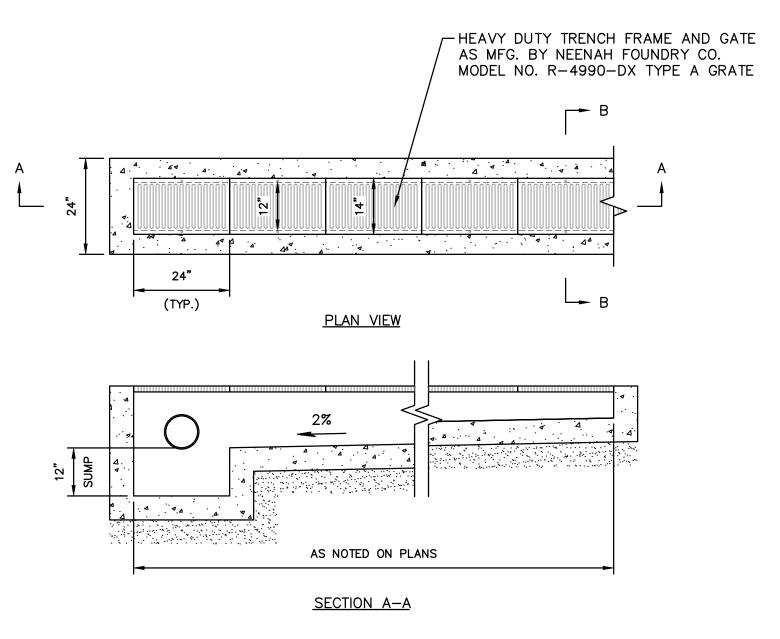

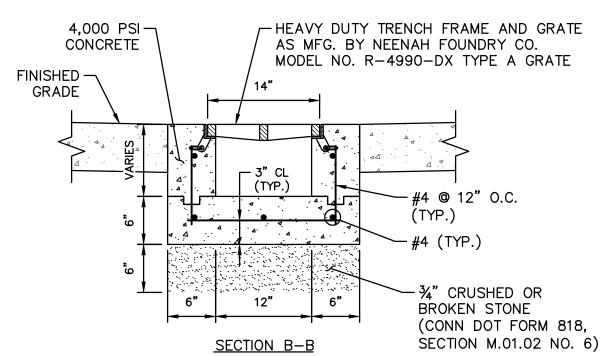


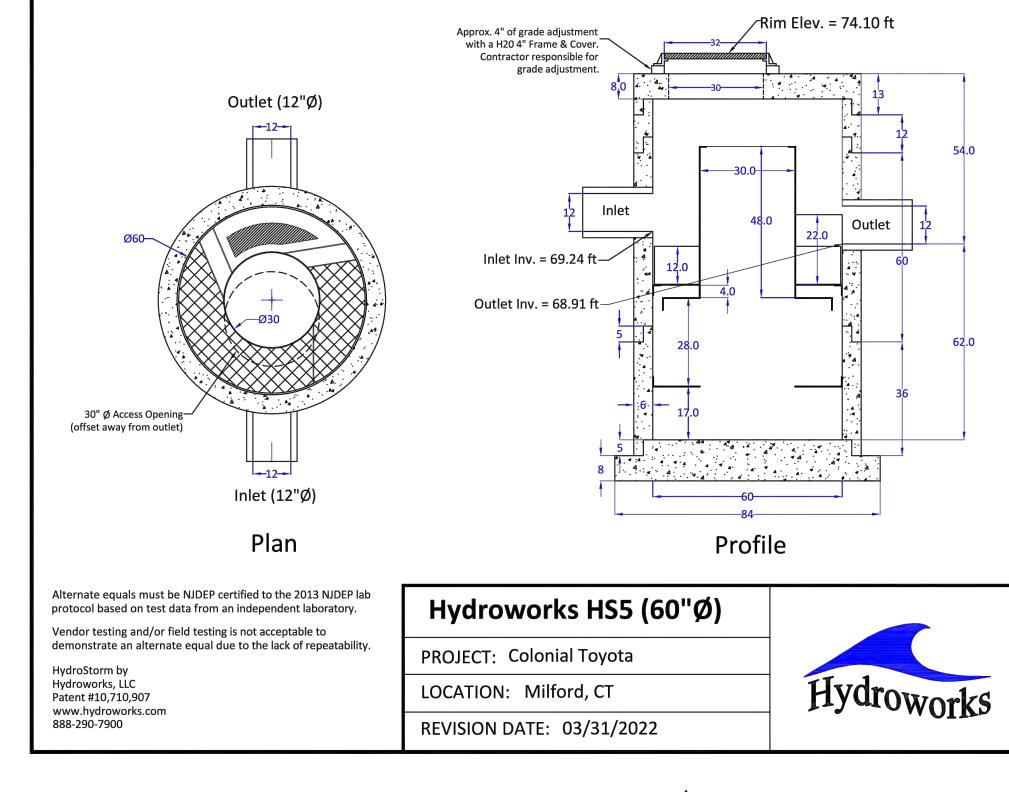




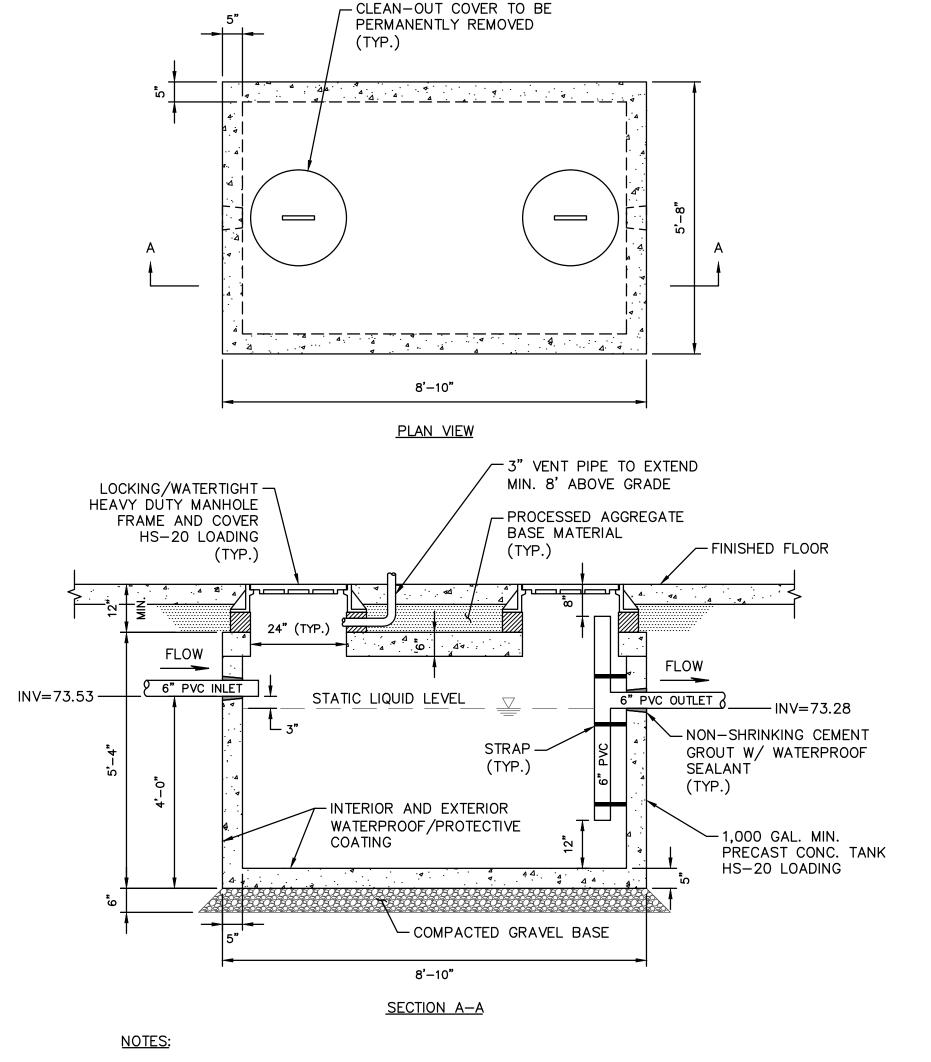

- 1. OIL/WATER SEPARATOR SHALL BE AS MANUFACTURED BY CONNECTICUT PRÉCAST CORPORATION, MONROE, CONNECTICUT, OR APPROVED EQUAL.
- 2. CONCRETE 4,000 PSI 28 DAYS.
- 3. JOINTS SHALL BE SEALED WITH BUTYL RUBBER SEALANT.

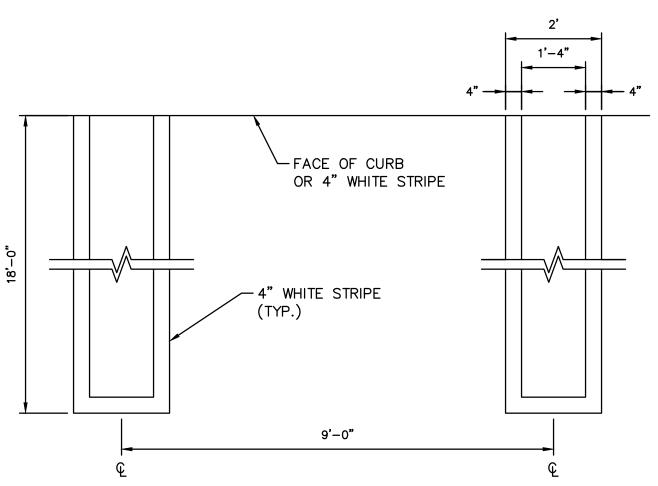


1,000 GALLON OIL/WATER SEPARATOR

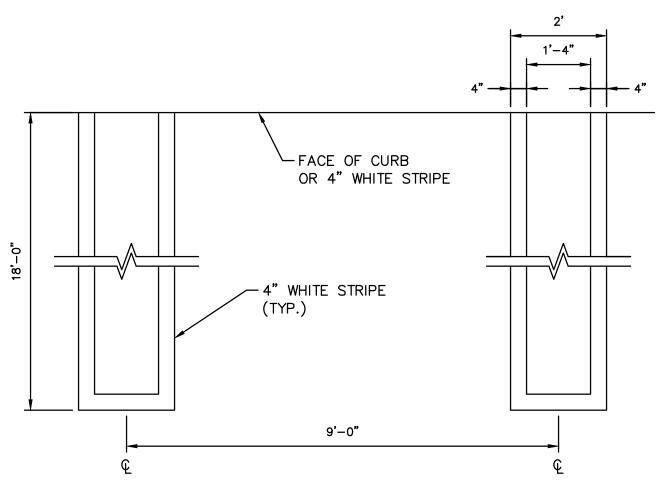


TYPICAL PARKING SPACE STRIPING N.T.S.

TRENCH DRAIN N.T.S.

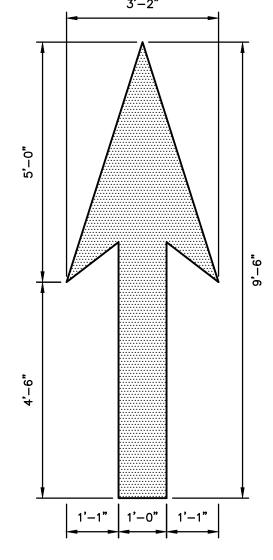


- NOTES:
- 1. ARROWS SHALL BE CENTERED IN TRAVEL LANE.
- 2. COLOR: WHITE
- 3. PAVEMENT ARROWS SHALL BE SOLID.

PAVEMENT ARROW N.T.S.

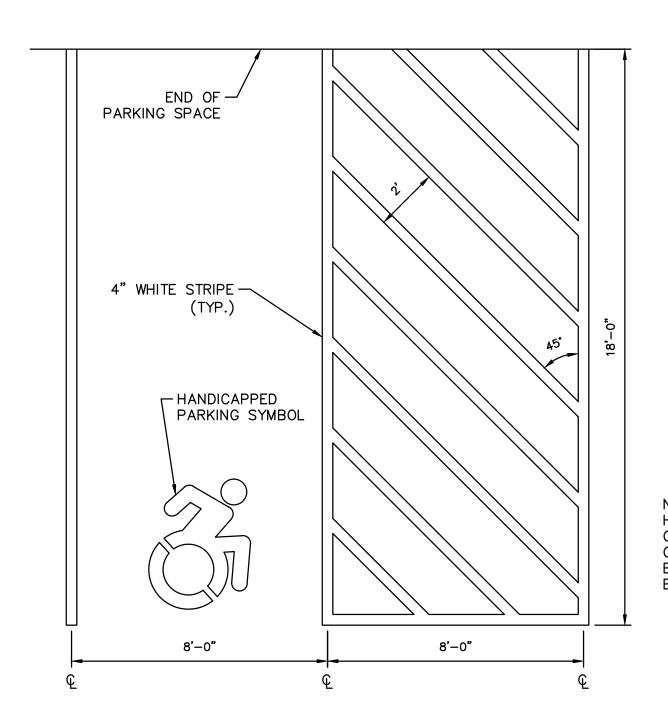

VAN ACCESSIBLE PARKING SPACE N.T.S.

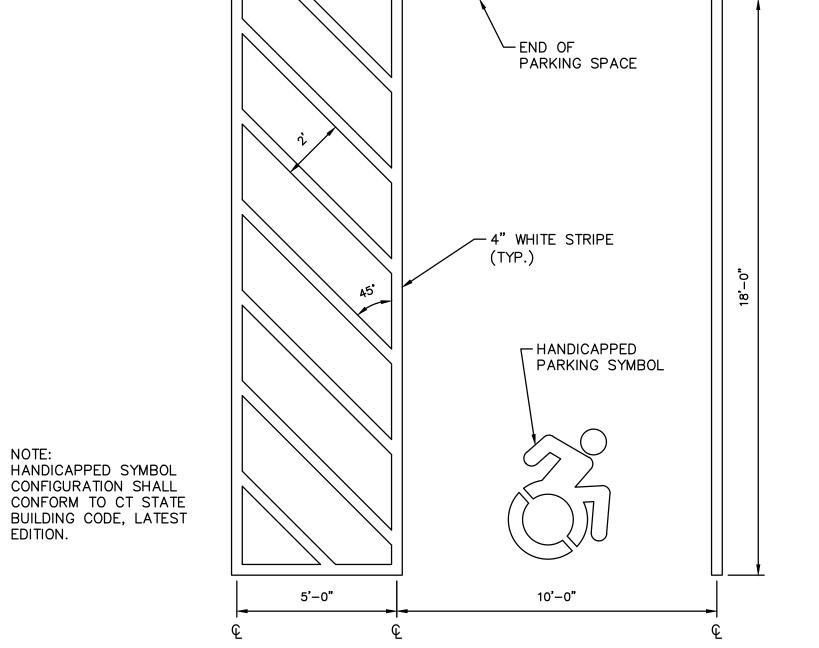

STANDARD ACCESSIBLE PARKING SPACE N.T.S.

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Revisions			Project Title
No.	Date	Description	COLONIAL TOYOT
1	07/01/22	REV WATER QUALITY UNIT	SERVICE CENTER
2	07/29/22	ADDED REV. DATE FOR CONTINUITY	
			BUILDING EXPANSI
			470 BOSTON POST ROAI
			MILFORD, CONNECTICUT


VIAL TOYOTA G EXPANSION TON POST ROAD



Drawing Title RGP | Date 03/09/2022 NWE Scale AS NOTED CONSTRUCTION **DETAILS** 21-090-10 E-mail: info@westcottandmapes.com 21-090-10 CIVIL

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MACHINE FORMED BITUMINOUS LIP CURB

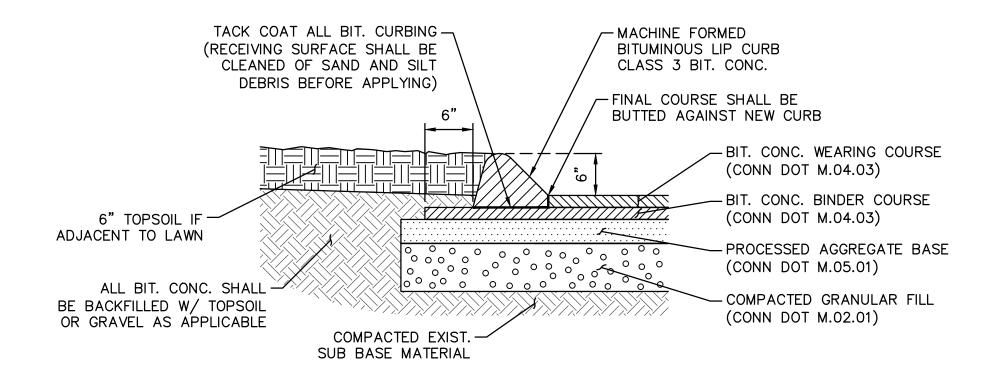

BITUMINOUS CONCRETE LIP CURBING

N.T.S.


-FINISH TOP OF CURB TO ACHIEVE DENSE/SMOOTH STEEL TROWELLED SURFACE FINISHED GRADE - IMMEDIATELY AFTER STRIPPING FORMS RUB FACE OF CURB W/ CARBORUNDUM STONE TO FILL ANY AIR BUBBLE PIN HOLES. ANY CURB EXHIBITING HONEYCOMB CONDITION IS UNACCEPTABLE AND IS TO BE REPLACED BETWEEN EXPANSION JOINTS. ROAD SURFACE -4,000 PSI CONC. W/ 5-7% AIR ENTRAINMENT COMPACTED GRANULAR FILL (CONN DOT FORM 818, SECTION M.02.01) - COMPACTED EXIST. SUB BASE MATERIAL NOTE:

STANDARD 6" HT. CONCRETE CURB

N.T.S.

1/2" PREMOLDED EXPANSION JOINTS SHALL BE INSTALLED AT 24' O.C. MAX. UNLESS

OTHERWISE SPECIFIED.

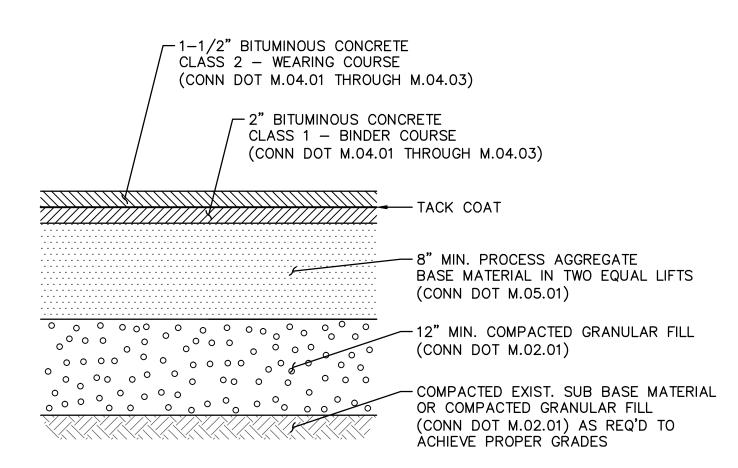



OTES:

- 1. ALL PAVED AREAS SHALL HAVE A MINIMUM OF 8" OF PROCESS AGGREGATE BASE MATERIAL BENEATH THE BINDER COURSE. RECLAMATION OF EXISTING MATERIAL MAY BE SUITABLE IN SOME AREAS OF EXISTING PARKING RECONSTRUCTION; CONFIRM WITH ENGINEER.
- 2. ALL EXISTING BASE MATERIAL OR RECLAIMED MATERIAL SHALL BE PROOF ROLLED TO THE SATISFACTION OF THE ENGINEER. SOFT YIELDING MATERIAL SHALL BE REMOVED AND REPLACED WITH A MINIMUM OF 8" OF NEW COMPACTED PROCESS AGGREGATE BASE MATERIAL AS DIRECTED BY THE FNGINFER
- 3. IN THE AREAS OF FILL, COMPACTED GRANULAR FILL SHALL BE USED TO ACHIEVE PROPER GRADES BENEATH THE BASE MATERIAL LAYER.
- 4. COMPACTED GRANULAR FILL MATERIAL SHALL COMPLY WITH CONNECTICUT (CONN) DOT FORM 818, SECTION M.02.01.
- 5. ALL MATERIALS SHALL BE COMPACTED TO NO LESS THAN 95 PERCENT OF THE DRY DENSITY FOR THE SOIL WHEN TESTED IN ACCORDANCE WITH AASHTO T180 METHOD 'D'.

FULL DEPTH PAVEMENT REPAIR


N.T.S.

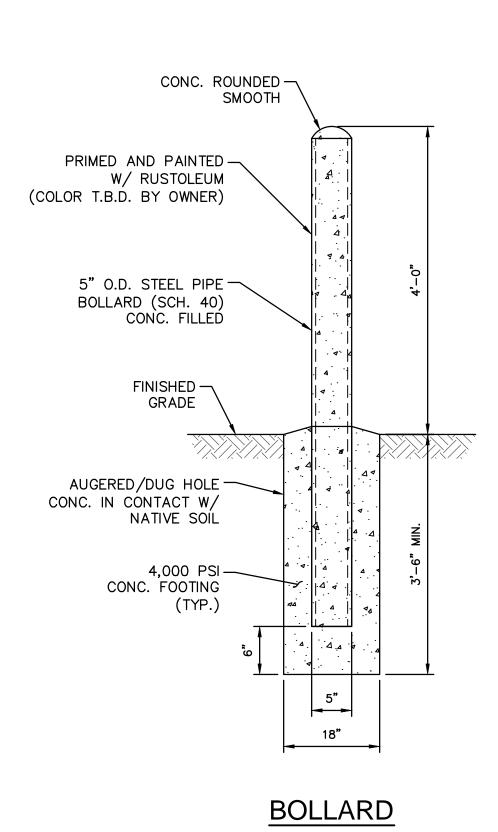

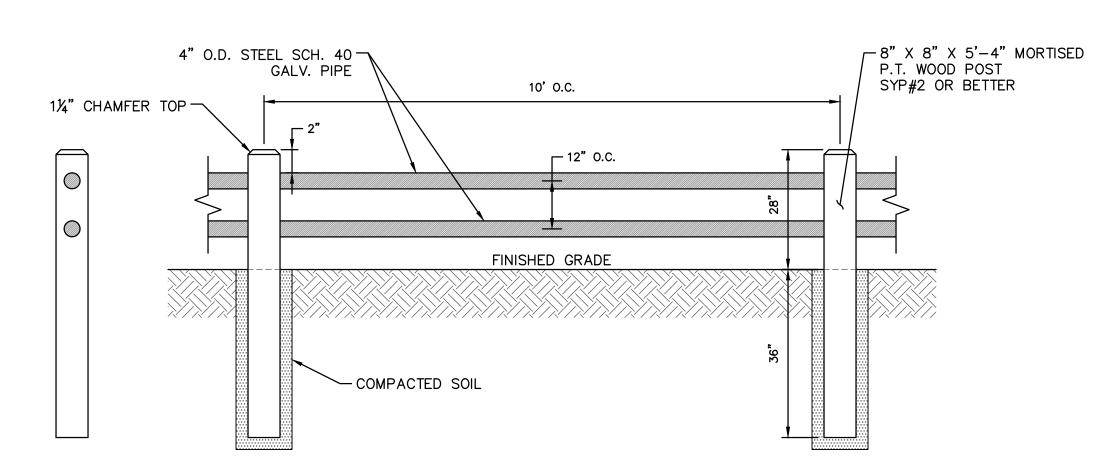

TWIN PIPE AND WOOD POST GUIDE RAIL

N.T.S.

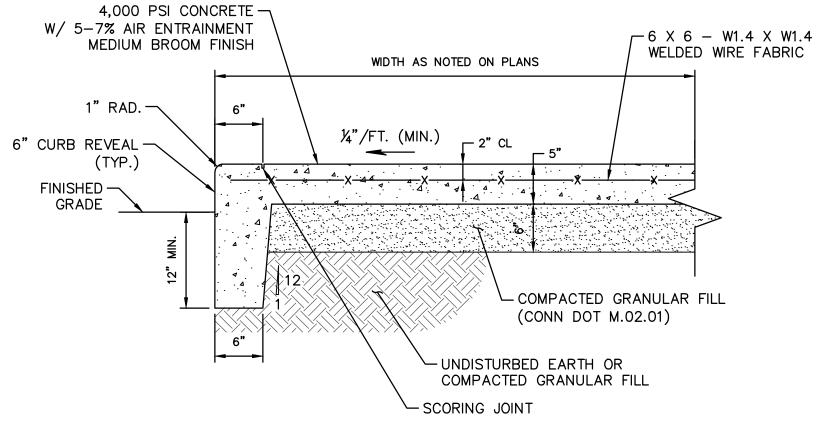


NOTES

- 1/2" PREMOLDED EXPANSION JOINTS SHALL BE INSTALLED AT 25' O.C. MAX, UNLESS OTHERWISE SPECIFIED.
- 2. EACH SLAB SHALL BE DIVIDED UP INTO SECTIONS BY FORMING SCORING JOINTS WITH A JOINTING TOOL. SCORING JOINTS SHALL BE 5' O.C. AND SHALL BE EVENLY SPACED ALONG THE LENGTH OF THE SLAB.
- 3. THE OUTSIDE EDGES OF THE SLAB AND ALL EXPANSIONS JOINTS SHALL BE EDGED WITH A 1/4" RADIUS EDGING TOOL.

INTEGRAL CONCRETE WALK AND CURB

N.T.S.

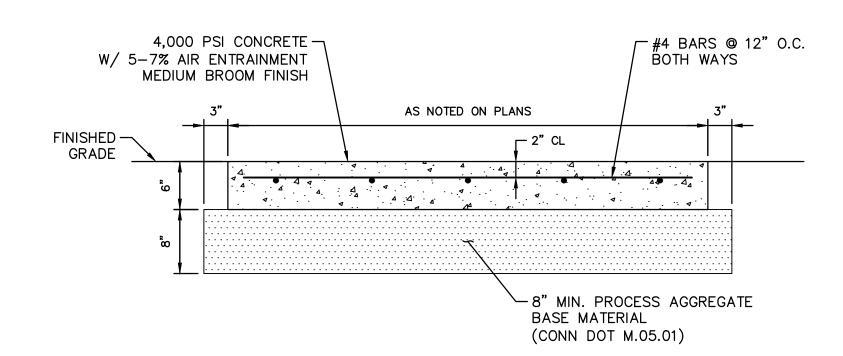

CONCRETE DUMPSTER PAD

Drawing Title

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1	07/01/22	ADDED REV. DATE FOR CONTINUITY	
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COLONIAL TOYOTA
"SERVICE CENTER"
BUILDING EXPANSION
470 BOSTON POST ROAD

MILFORD, CONNECTICUT



E-mail: info@westcottandmapes.com

CONSTRUCTION DETAILS

Designed RGP Date 03/09/2022

Drawn NWE Scale AS NOTED

Approved 21-090-10
Project No. 21-090-10 CIVIL
File Name

